# REPAIR STORM DAMAGE & REPLACE ROOF JACKSON READINESS CENTER JACKSON, MISSOURI

OWNER:

STATE OF MISSOURI

MICHAEL L. PARSON,

**GOVERNOR** 

DEPARTMENT OF PUBLIC SAFETY MISSOURI NATIONAL GUARD

OFFICE OF THE ADJUTANT GENERAL

FACILITIES DIVISION

**PROJECT** OFFICE OF ADMINISTRATION

DIVISION OF FACILITIES MANAGEMENT, MANAGEMENT:

DESIGN AND CONSTRUCTION



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**DESIGNER:** Farnsworth Group, Inc.

PROJECT NUMBER: T1931-01

SITE NUMBER: ASSET NUMBER: 6312

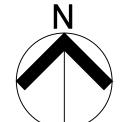
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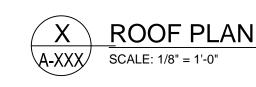


SYMBOLS / ABBREVIATIONS

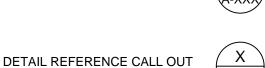
NORTH ARROW



DETAIL TITLE



SECTION CUT CALL OUT



**KEYNOTE** 

**EMERGENCY** 

EQUIPMENT

EXISTING

**EXTERIOR** 

ELECTRIC WATER COOLER

**EQUAL** 

**EMER** 

**EXIST** 

EXT

EWC

(14)

AFF ACP/APC	ABOVE FINISHED FLOOR ACOUSTIC CEILING PANEL/	FD FE	FLOOR DRAIN FIRE EXTINGUISHER	PEB PJF	PRE-ENGINEERED BUILDING PREFORMED JOINT FILLER
A O.T.	ACOUSTIC PANEL CEILING	FFE	FINISH FLOOR ELEVATION	PT	PRESSURE TREATED
ACT	ACOUSTIC(AL) TILE	FV	FIELD VERIFY	PERIM	PERIMETER PLATE
ADJ''	ADDITIONAL	FEC	FIRE EXTINGUISHER CABINET	PL AM	
ADT'L AGG	ADDITIONAL AGGREGATE	FDN FIN	FOUNDATION FINISH	PLAM PLBG	PLASTIC LAMINATE PLUMBING
ALT	ALTERNATE	FLSHG	FLASHING	PLYWD	PLYWOOD
AL	ALUMINUM	FLR	FLOOR	PNT	PAINT
APPROX	APPROXIMATE(LY)	FRMG	FRAMING	PR	PAIR
ASPH	ASPHALT	FT	FOOT/FEET	PTD	PAINTED
AUTO	AUTOMATIC	FTG	FOOTING	PWR	POWER
D/O	DOTTOM OF	00	OFNEDAL CONTRACTOR	DD	DUDDED DAGE
B/O BD	BOTTOM OF	GC GA	GENERAL CONTRACTOR	RB	RUBBER BASE
BLDG	BOARD BUILDING	GA GALV	GAUGE GALVANIZED	RD RO	ROOF DRAIN ROUGH OPENING
BLKG	BLOCKING	GEN	GENERAL	RAD	RADIUS
BOT	BOTTOM	GYP	GYPSUM	REC	RECESSED
BRG	BEARING	011	011 00W	REINF	REINFORCED
DICO	DE/ II (II V	НМ	HOLLOW METAL	REQ'D	REQUIRED
<b>©</b>	CENTERLINE	HDWR	HARDWARE	REV	REVISED (REVISION)
C/C	CENTER TO CENTER	HOL	HOLLOW	RM	ROOM
CJ	CONTROL JOINT	HOR	HORIZONTAL		
CLL	CONTRACT LIMIT LINE	HT	HEIGHT		
CEM	CEMENT(ITIOUS)	HVAC	HEATING/VENTILATION/AIR	S	SOUTH
CMU	CONCRETE MASONRY UNIT		CONDITIONING	SB	SPLASH BLOCK
CLG	CEILING			SF	SQUARE FEET
CLR	CLEAR	IDPH	ILLINOIS DEPARTMENT OF	SS	STAINLESS STEEL
COL	COLUMN		PUBLIC HEALTH	SIM	SIMILAR
CONC	CONCRETE	ID	INSIDE DIAMETER	SPEC	SPECIFICATIONS
CONST	CONSTRUCTION	IN	INCH	SQ	SQUARE
CONT CPT	CONTINUOUS CARPET	INCL INSUL	INCLUDING INSULATION	STD STL	STANDARD STEEL
CT	CERAMIC TILE	INT	INTERIOR	STOR	STORAGE
CTR	CENTER(ED)	IINI	INTERIOR	STRUCT	STRUCTURAL
OTIK	OLIVILIN(LD)	JAN	JANITOR	SUSP	SUSPENDED
DF	DRINKING FOUNTAIN	JT	JOINT	000.	0001 211020
DS	DOWNSPOUT	0.	30	T&G	TONGUE AND GROOVE
DBL	DOUBLE	LAV	LAVATORY	T/O	TOP OF
DEG	DEGREE	LB(S)	POUND(S)	TELE	TELEPHONE
DEMO	DEMOLITION	L/S	LANDSCAPE	TRTD	TREATED
DET/DTL	DETAIL	LT	LIGHT	TS	TUBE STEEL
DIA	DIAMETER			TYP	TYPICAL
DIM	DIMENSION	MO	MASONRY OPENING		
DN DN	DOWN	MAS	MASONRY	UNFIN	UNFINISHED
DWG(S)	DRAWING(S)	MAT'L	MATERIAL	UNO	UNLESS NOTED OTHERWISE
		MAX	MAXIMUM	VCT	VINYL COMPOSITION TILE
E	EAST	MECH MFR	MECHANICAL MANUFACTURER	VCT VIF	VERIFY IN FIELD
EC	ELECTRICAL CONTRACTOR	MIN	MINIMUM	VERT	VERTICAL
EHO	ELECTRICAL HOLD OPEN	MISC	MISCELLANEOUS	VLIXI	VERTIOAL
EJ	EXPANSION JOINT	MTD	MOUNTED	W	WEST
EW	EACH WAY	MTL	METAL	W/	WITH
EA	EACH	N	NORTH	W/O	WITHOUT
EIFS	EXTERIOR INSULATION	NIC	NOT IN CONTRACT	WC	WATER CLOSET
	FINISH SYSTEM	NTS	NOT TO SCALE	WWF	WELDED WIRE FABRIC
EL	ELEVATION	NOM	NOMINAL	WD	WOOD
ELEC	ELECTRIC(AL)			WH	WATER HEATER
ELEV	ELEVATOR	OC	ON CENTER	WT	WEIGHT

OUTSIDE DIAMETER

OUT TO OUT

OPENING

OPPOSITE

OVHD OVERHEAD

O TO 0

OPP

#### DESCRIPTION OF EXISTING CONDITIONS AND SCOPE OF WORK

#### A.EXISTING CONDITIONS:

- 1. THE EXISTING ROOFING COMPOSITION IS BELIEVED TO CONSIST OF A FULLY ADHERED EPDM SINGLE-PLY MEMBRANE OVER POLYISOCYANURATE INSULATION BOARD OVER AN EXISTING LIGHTWEIGHT GYPSUM CONCRETE ROOF DECK OVER AN EXISTING METAL ROOF FORM DECK OVER A STEEL BAR JOIST ROOF STRUCTURE. THERE ARE EXISTING METAL ROOF FLASHINGS, GUTTERS AND DOWNSPOUTS PRESENT.
- 2. THE EXISTING MATERIALS HAVE BEEN TESTED FOR ASBESTOS CONTAINING MATERIALS (ACM). SEE SPECIFICATION FOR TESTING REPORT. FOLLOW METHODS OF REMOVAL AS SPECIFIED.
- 3. OWNER WILL REMOVE FURNITURE FROM THE OFFICE AREAS.

#### B. WORK INCLUDES THE FOLLOWING:

- 1. REMOVAL OF ALL EXISTING ROOFING SYSTEM COMPONENTS INCLUDING EPDM MEMBRANE, INSULATION ASSEMBLIES, ADHESIVES, FASTENERS, ETC. DOWN TO THE EXISTING LIGHTWEIGHT GYPSUM CONCRETE ROOF DECK. IF NECESSARY, SELECTIVE METAL ROOF DECKING REPLACEMENT MAY BE REQUIRED IN THE SPECIFIC AREAS INDICATED ON THE ROOF PLAN. THIS INCLUDES ALL EXISTING METAL ROOF FLASHINGS, GUTTERS AND DOWNSPOUTS.
- 2. REPAIR AND REPLACEMENT OF ANY DETERIORATED LIGHTWEIGHT GYPSUM CONCRETE
- 3. INSTALLATION OF NEW TREATED WOOD BLOCKING (PERIMETER, CURBS, ETC.).
- 4. INSTALLATION OF GYPSUM BOARD SHEATHING MECHANICALLY FASTENED TO LIGHTWEIGHT GYPSUM CONCRETE ROOF DECK.
- 5. INSTALLATION OF NEW POLYISOCYANURATE ROOF INSULATION UTILIZING ROOFING MANUFACTURER'S APPROVED BONDING ADHESIVE.
- 6. INSTALLATION OF A NEW FULLY ADHERED TPO ROOFING MEMBRANE ASSEMBLY
- INCLUDING FLASHINGS, GUTTERS.

  7. REPAIRS TO INTERIOR FINISHES DUE TO WATER DAMAGE INCLUDING FLOOR AND WALL FINISHES, PAINTING, AND CEILING REPAIR.

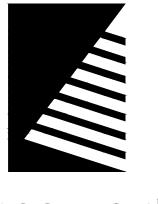
#### GENERAL NOTES FOR ROOFING WORK (NOTES APPLY TO ENTIRE PROJECT)

- 1. THESE DRAWINGS HAVE BEEN PREPARED ON THE COMBINED BASIS OF PLANS AND INFORMATION PROVIDED TO OUR OFFICE BY THE USING AGENCY AS WELL AS OBSERVATIONS WE HAVE CONDUCTED AT THE PROJECT SITE. THE GENERAL INTENT OF THESE BIDDING DOCUMENTS (I.E. DRAWINGS AND SPECIFICATIONS) IS TO ILLUSTRATE THE PHYSICAL CONDITIONS PRESENT AT THE PROJECT SITE.
- 2. PRIOR TO SUBMITTING THEIR BID, EACH CONTRACTOR IS REQUIRED TO VERIFY ALL CONDITIONS AT THE PROJECT SITE AND FULLY INFORM THEMSELVES OF ALL EXISTING CONDITIONS THAT MAY AFFECT THEIR WORK. EACH CONTRACTOR SHALL INSPECT ALL AREAS WHERE RE-ROOFING WORK IS SCHEDULED TO BE PERFORMED AND SHALL INCLUDE IN THEIR BIDS ANY ADDITIONAL WORK THAT MAY BE REQUIRED IN ORDER TO PERFORM THE SPECIFIED WORK.
- 3. THE CONTRACTOR IS RESPONSIBLE FOR CORRECTION OF ANY AND ALL DAMAGES TO THE SITE, BUILDING AND/OR CONTENTS INCURRED AS A RESULT OF THE CONTRACTOR'S (OR SUB-CONTRACTOR'S, SUPPLIERS, ETC.) WORK OPERATIONS TO THE SATISFACTION OF THE USING AGENCY AND ARCHITECT. SUCH CORRECTIVE WORK MUST BE PERFORMED AT NO ADDITIONAL COST TO THE USING AGENCY OR ARCHITECT.
- 4. THE CONTRACTOR SHALL CONFINE THEIR WORK OPERATIONS TO THOSE AREAS WHICH ARE SPECIFICALLY SCHEDULED FOR RE-ROOFING WORK AND MUST COORDINATE ALL WORK WITH THE USING AGENCY IN ORDER TO AVOID AND/OR MINIMIZE THE DISRUPTION OF NORMAL BUILDING OPERATION.
- 5. THE CONTRACTOR IS RESPONSIBLE FOR MAINTAINING ALL AREAS OF WORK WATERTIGHT AT ALL TIMES THROUGHOUT THE DURATION OF THE ENTIRE PROJECT.
- 6. THE USING AGENCYS MAINTENANCE PERSONNEL, STAFF AND ADMINISTRATION WILL OCCUPY THE BUILDING DURING THE RE-ROOFING CONSTRUCTION PERIOD. WHEREVER WORK OPERATIONS OCCUR NEXT TO A BUILDING ENTRANCE, THE CONTRACTOR MUST PROVIDE PROTECTIVE BARRIERS OR BARRICADES TO ALLOW PROPER AND ADEQUATE BUILDING ACCESS AND UNOBSTRUCTED EGRESS.
- 7. THE CONTRACTOR IS REQUIRED TO COMMUNICATE WITH BOTH THE USING AGENCY AND THE ARCHITECT ON A DAILY BASIS OF THE CURRENT WORK SCHEDULE SO PROPER COORDINATION AND SCHEDULING FOR OBSERVATION OF WORK AND COORDINATION WITH AGENCY ACTIVITIES CAN OCCUR.
- 8. ALL RE-ROOFING WORK SHALL BE EXECUTED IN ACCORDANCE WITH THE DRAWINGS AND SPECIFICATIONS PREPARED BY THE ARCHITECT; HOWEVER, IN NO CASE SHALL RE-ROOFING INSTALLATION DEVIATE FROM THE ROOFING SYSTEM MANUFACTURER'S MINIMUM WARRANTY REQUIREMENTS. IF ANY SUCH DISCREPANCIES OCCUR, THE CONTRACTOR MUST NOTIFY THE ARCHITECT IMMEDIATELY. RESOLUTION MUST BE MADE BEFORE PROCEEDING WITH ANY SUCH WORK.
- 9. UNLESS NOTED OTHERWISE, ALL NEW SHEET METAL WORK ASSOCIATED WITH RE-ROOFING WORK SHALL COMPLY WITH RECOMMENDATIONS AND DETAILS IN THE MOST CURRENT EDITION OF "ARCHITECTURAL SHEET METAL MANUAL" PUBLISHED BY SMACNA. SEE DETAILS FOR TYPE, GAUGE AND FINISH OF NEW SHEET METAL COMPONENTS.
- 10. THE CONTRACTOR SHALL CAREFULLY EXAMINE THE EXISTING ROOF DECK SURFACE AT EACH ROOF AREA JUST PRIOR TO THE INSTALLATION OF THE NEW ROOFING SYSTEM AND REMOVE ALL NAILS, FASTENERS AND OTHER FOREIGN MATERIAL, WHEREAS TO PROVIDE A REASONABLY SMOOTH SURFACE FOR THE APPLICATION OF NEW ROOFING MATERIALS.
- 11. ALL NEW TAPERED INSULATION CRICKETS AND ROOF SADDLES INDICATED ON THE DRAWINGS SHALL UTILIZE A 1/2" PER FOOT TAPERED POLYISOCYANURATE INSULATION SYSTEM (POLYISO).
- 12. EXCEPT AS OTHERWISE INDICATED ON THE DRAWINGS, ALL WOOD BLOCKING AND PLYWOOD SHALL BE PRESSURE TREATED. ALL FASTENERS INSTALLED EITHER IN CONTACT OR FOR INSTALLATION OF PRESSURE TREATED WOOD SHALL BE STAINLESS STEEL OR HAVE A CORROSION-RESISTANT COATING SPECIFICALLY DESIGNED AND SUITABLE FOR USE WITH PRESSURE TREATED WOOD.
- 13. SEALANT FOR EXTERIOR JOINTS SHALL BE ONE AND/OR TWO PART POLYURETHANE, SOFT CURING, NON-STAINING, OF GUN CONSISTENCY IN COLOR TO CLOSELY MATCH ADJACENT MATERIALS. CLEAN AND PRIME ALL JOINTS AS REQUIRED PRIOR TO SEALANT INSTALLATION.
- 14. CONTRACTOR SHALL RAISE AND EXTEND ALL EXISTING EXHAUST FANS, AND EQUIPMENT CURBS TO PROVIDE A MINIMUM CLEARANCE OF 12" ABOVE FINISHED ROOF LEVEL. THE CONTRACTOR SHALL INCLUDE IN THEIR BID THE EXTENSION OF ALL EXISTING, PIPING, DUCTWORK AND/OR ELECTRICAL WORK AS MAY BE REQUIRED TO ACCOMMODATE THE ADDITIONAL CURB HEIGHTS. PROVIDE A CONTINUOUS SEAL STRIP ON TOP OF LEVEL CURBS PRIOR TO RESETTING UNITS. NEW CURB EXTENSIONS SHALL MATCH EXISTING CURB PROFILES AND BLOCKING THICKNESS. THE CONTRACTOR SHALL TEST RUN EACH POWER ROOF EXHAUST AND/OR HANDLING UNIT, IN THE PRESENCE OF THE ARCHITECT'S REPRESENTATIVE OR USING AGENCY PRIOR TO DISCONNECTING AND RAISING THE UNIT AND EXTENDING THE CURBS. THIS INCLUDES BUT IS NOT LIMITED TO ALL ANCILLARY GAS PIPING, ELECTRICAL CONNECTIONS, DUCTWORK, ETC.
- 15. RAISE AND EXTEND EXISTING ALL PLUMBING VENTS AS REQUIRED TO OBTAIN A MINIMUM CLEARANCE OF 12" FROM THE TOP OF THE PLUMBING VENT FLASHING TO TOP OF THE NEW ROOF (I.E. ABOVE FINISHED ROOF LEVEL).
- 16. THE CONTRACTOR SHALL NOT TRAFFIC UPON, OR STORE MATERIALS ON ANY EXISTING ROOF AREAS WHICH ARE NOT A PART OF THIS CONTRACT.

#### STATE OF MISSOURI MICHAEL L. PARSON, GOVERNOR



DATE: 8/1/19 EXP: 12/31/20



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REPAIR STORM DAMAGE & REPLACE ROOF

JACKSON READINESS CENTER 224 W PARK ST. JACKSON, MISSOURI

PROJECT # T1931-01 SITE # 6312

8136312001

REVISION:
DATE:
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DATE: ISSUE DATE: 08/01/2019

CAD DWG FILE:

T1931-01.6312A-002

DRAWN BY: NWK

CHECKED BY: NRB

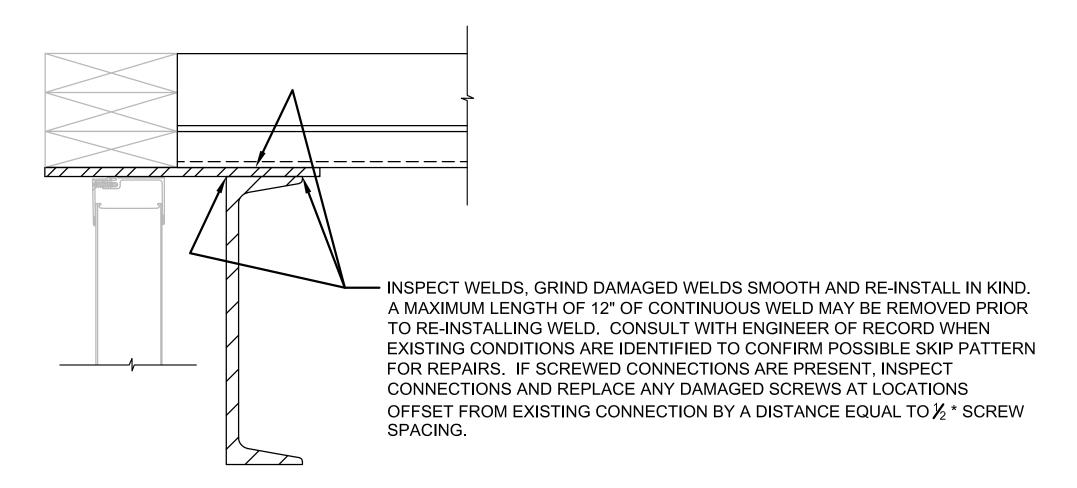
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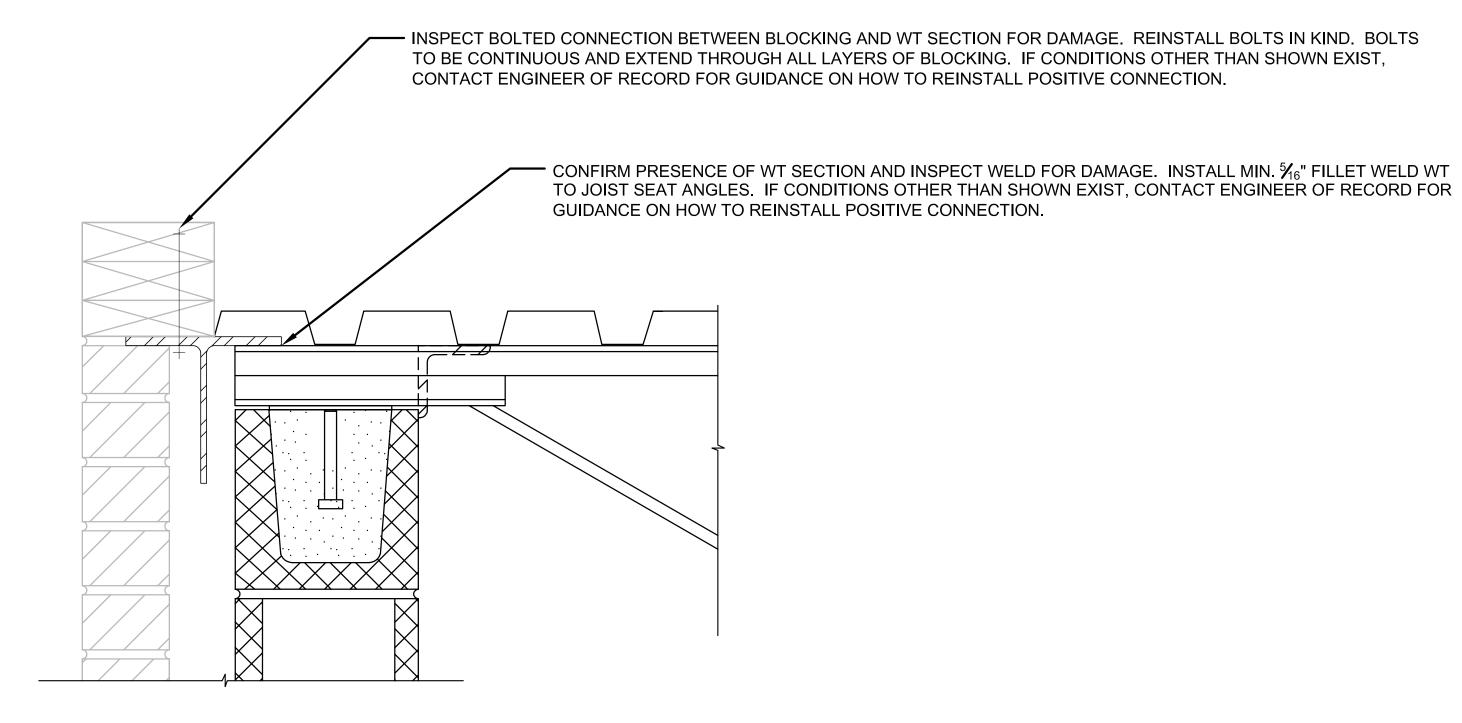
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GENERAL NOTES

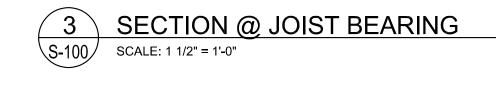
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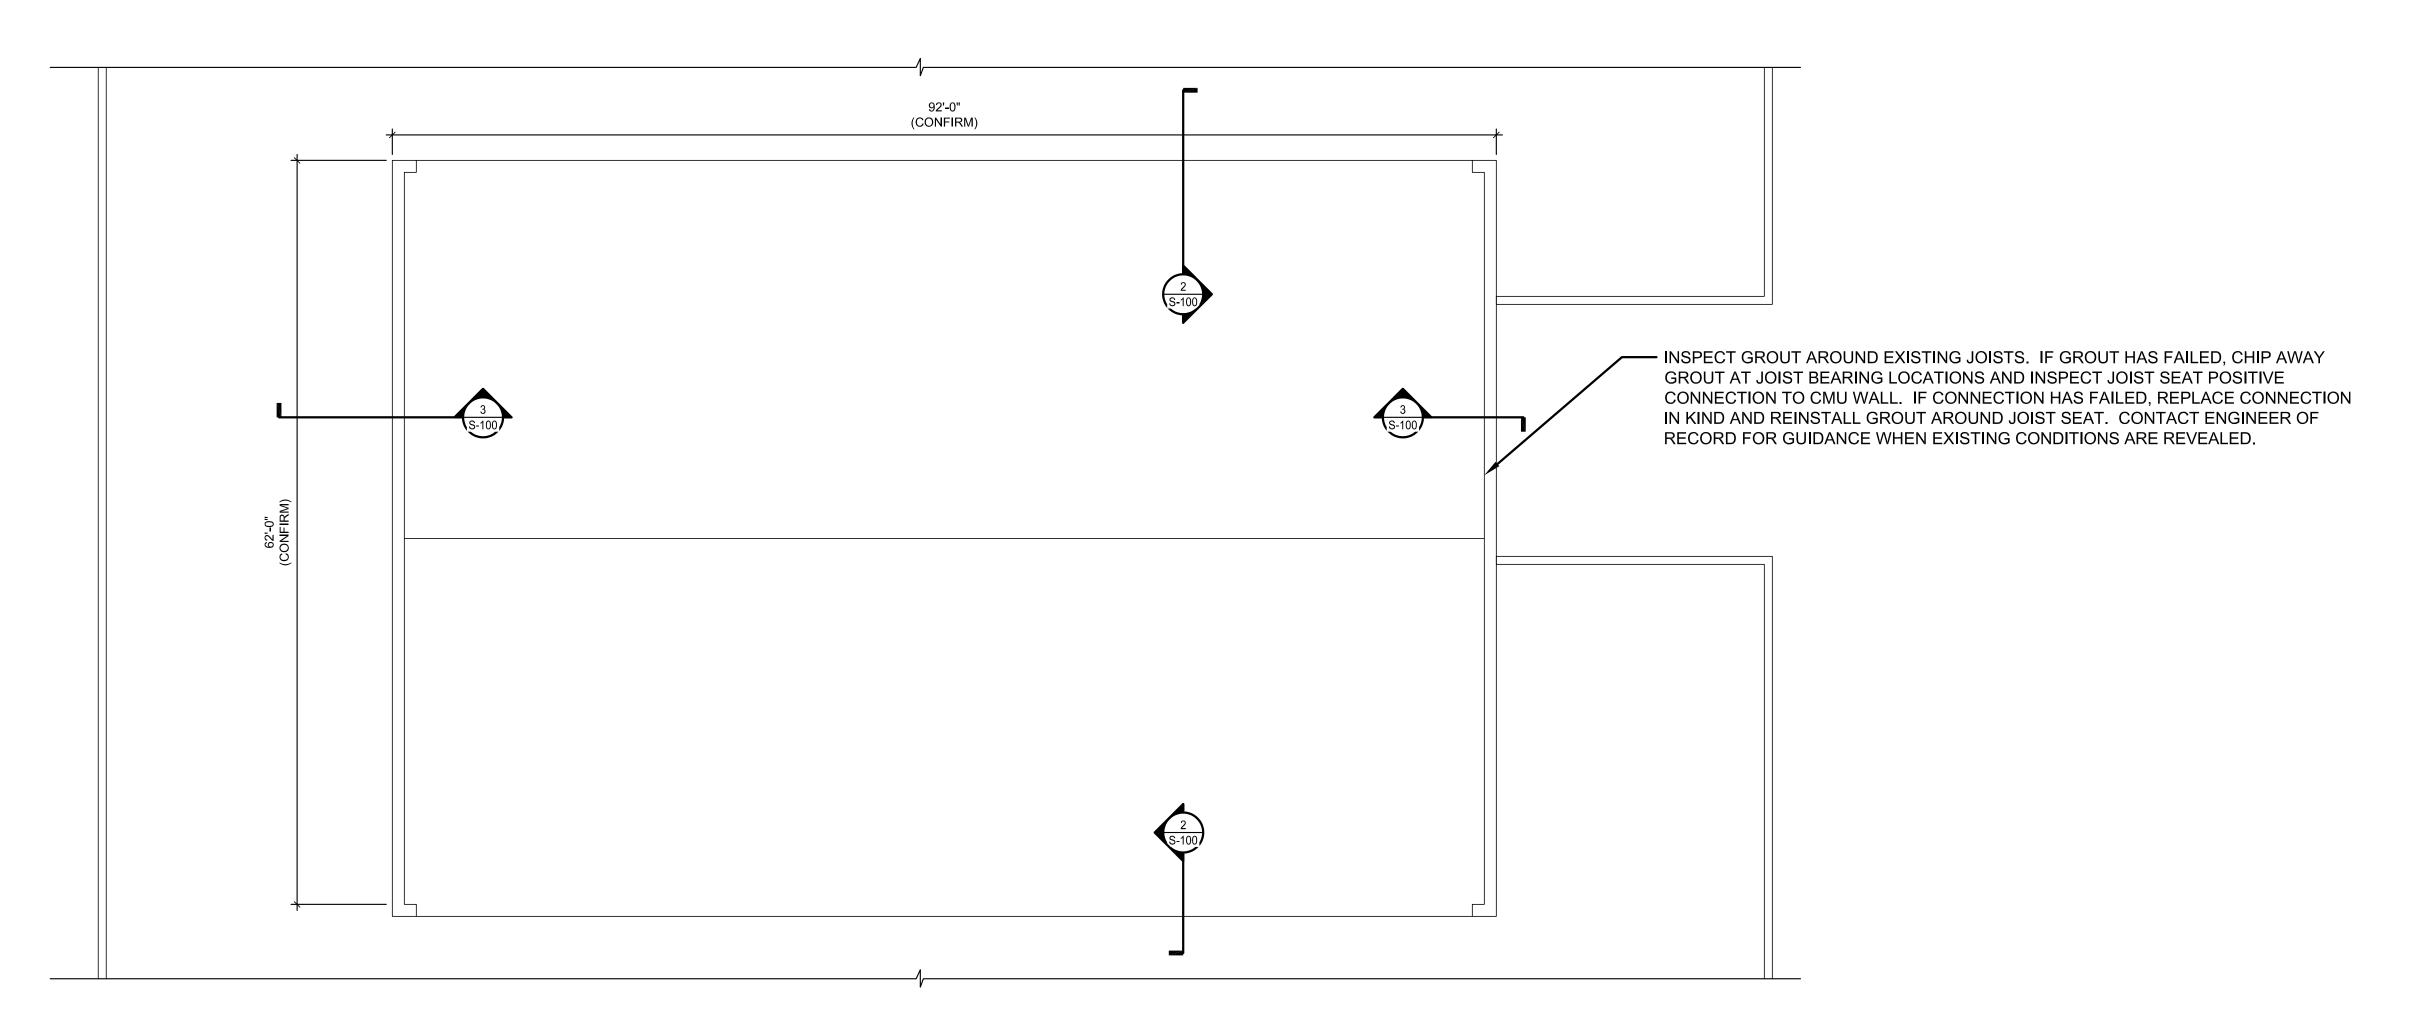







S-100 SCALE: 1 1/2" = 1'-0"







#### STATE OF MISSOURI MICHAEL L. PARSON, GOVERNOR

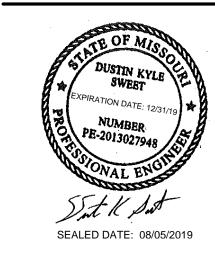



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REPAIR STORM DAMAGE & REPLACE ROOF

JACKSON READINESS CENTER 224 W Park St. JACKSON, MISSOURI 63755

PROJECT # T1931-01 SITE # 6312 ASSET # 8136312001

REVISION:
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ISSUE DATE: 08/01/2019


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CHECKED BY: CAS
DESIGNED BY: DKS

SHEET TITLE:

ROOF FRAMING PLAN

SHEET NUMBER:

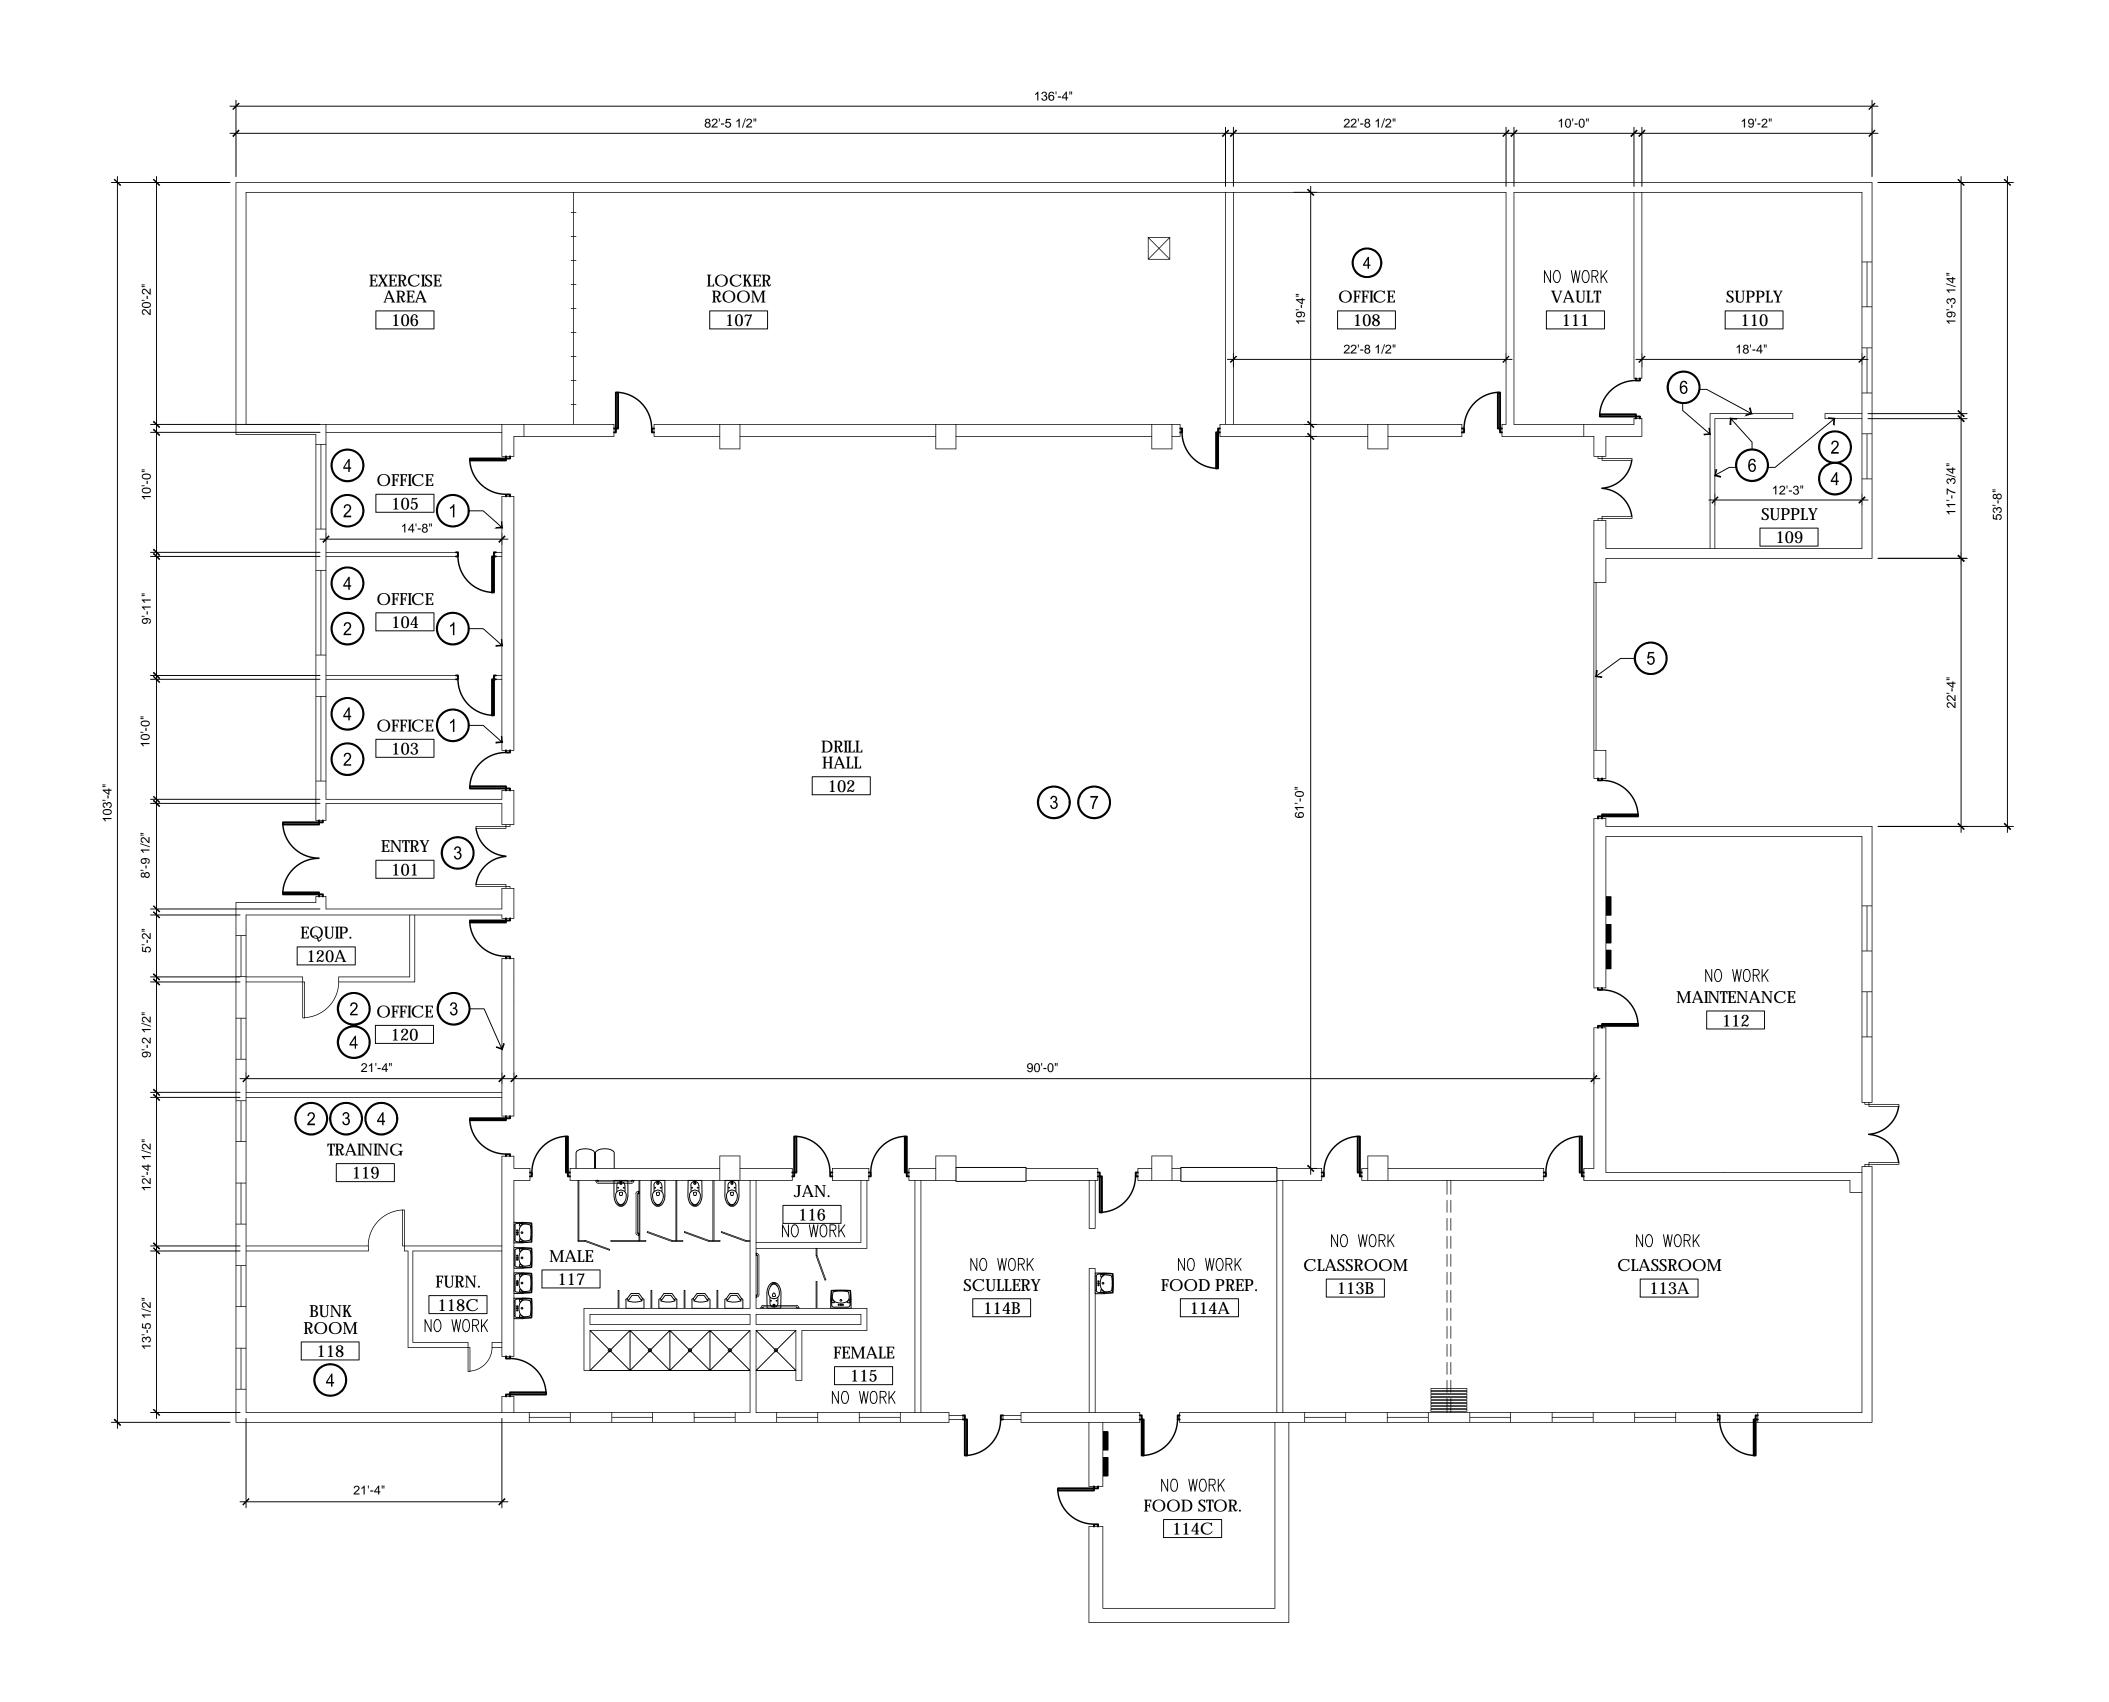
S-100



#### **KEYNOTES**

- 1) REMOVE GYP. BD. UP TO 2'-0".
- 2 REMOVE WALL BASE.
- (3) PREP. WALL FOR PAINT.
- (4) REMOVE FLOORING PREP FOR NEW FLOOR FINISH SEE INTERIOR DRAWINGS.
- (5) REMOVE EXISTING OVERHEAD DOOR, TRACK, AND DOOR OPENER.
- (6) REMOVE WALL PANEL FOR INSPECTION.
- 7) PREP FOR DECK/ STRUCTURE PAINT.

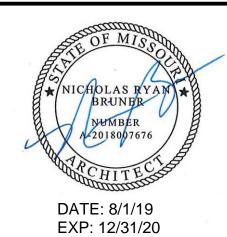STATE OF MISSOURI MICHAEL L. PARSON, **GOVERNOR** 





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REPAIR STORM DAMAGE & REPLACE ROOF

**JACKSON** READINESS CENTER 224 W PARK ST. JACKSON, MISSOURI 63755

PROJECT # T1931-01 SITE# 6312 8136312001 ASSET#

**REVISION: REVISION: REVISION:** DATE: ISSUE DATE: 08/01/2019

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DESIGNED BY: BTW

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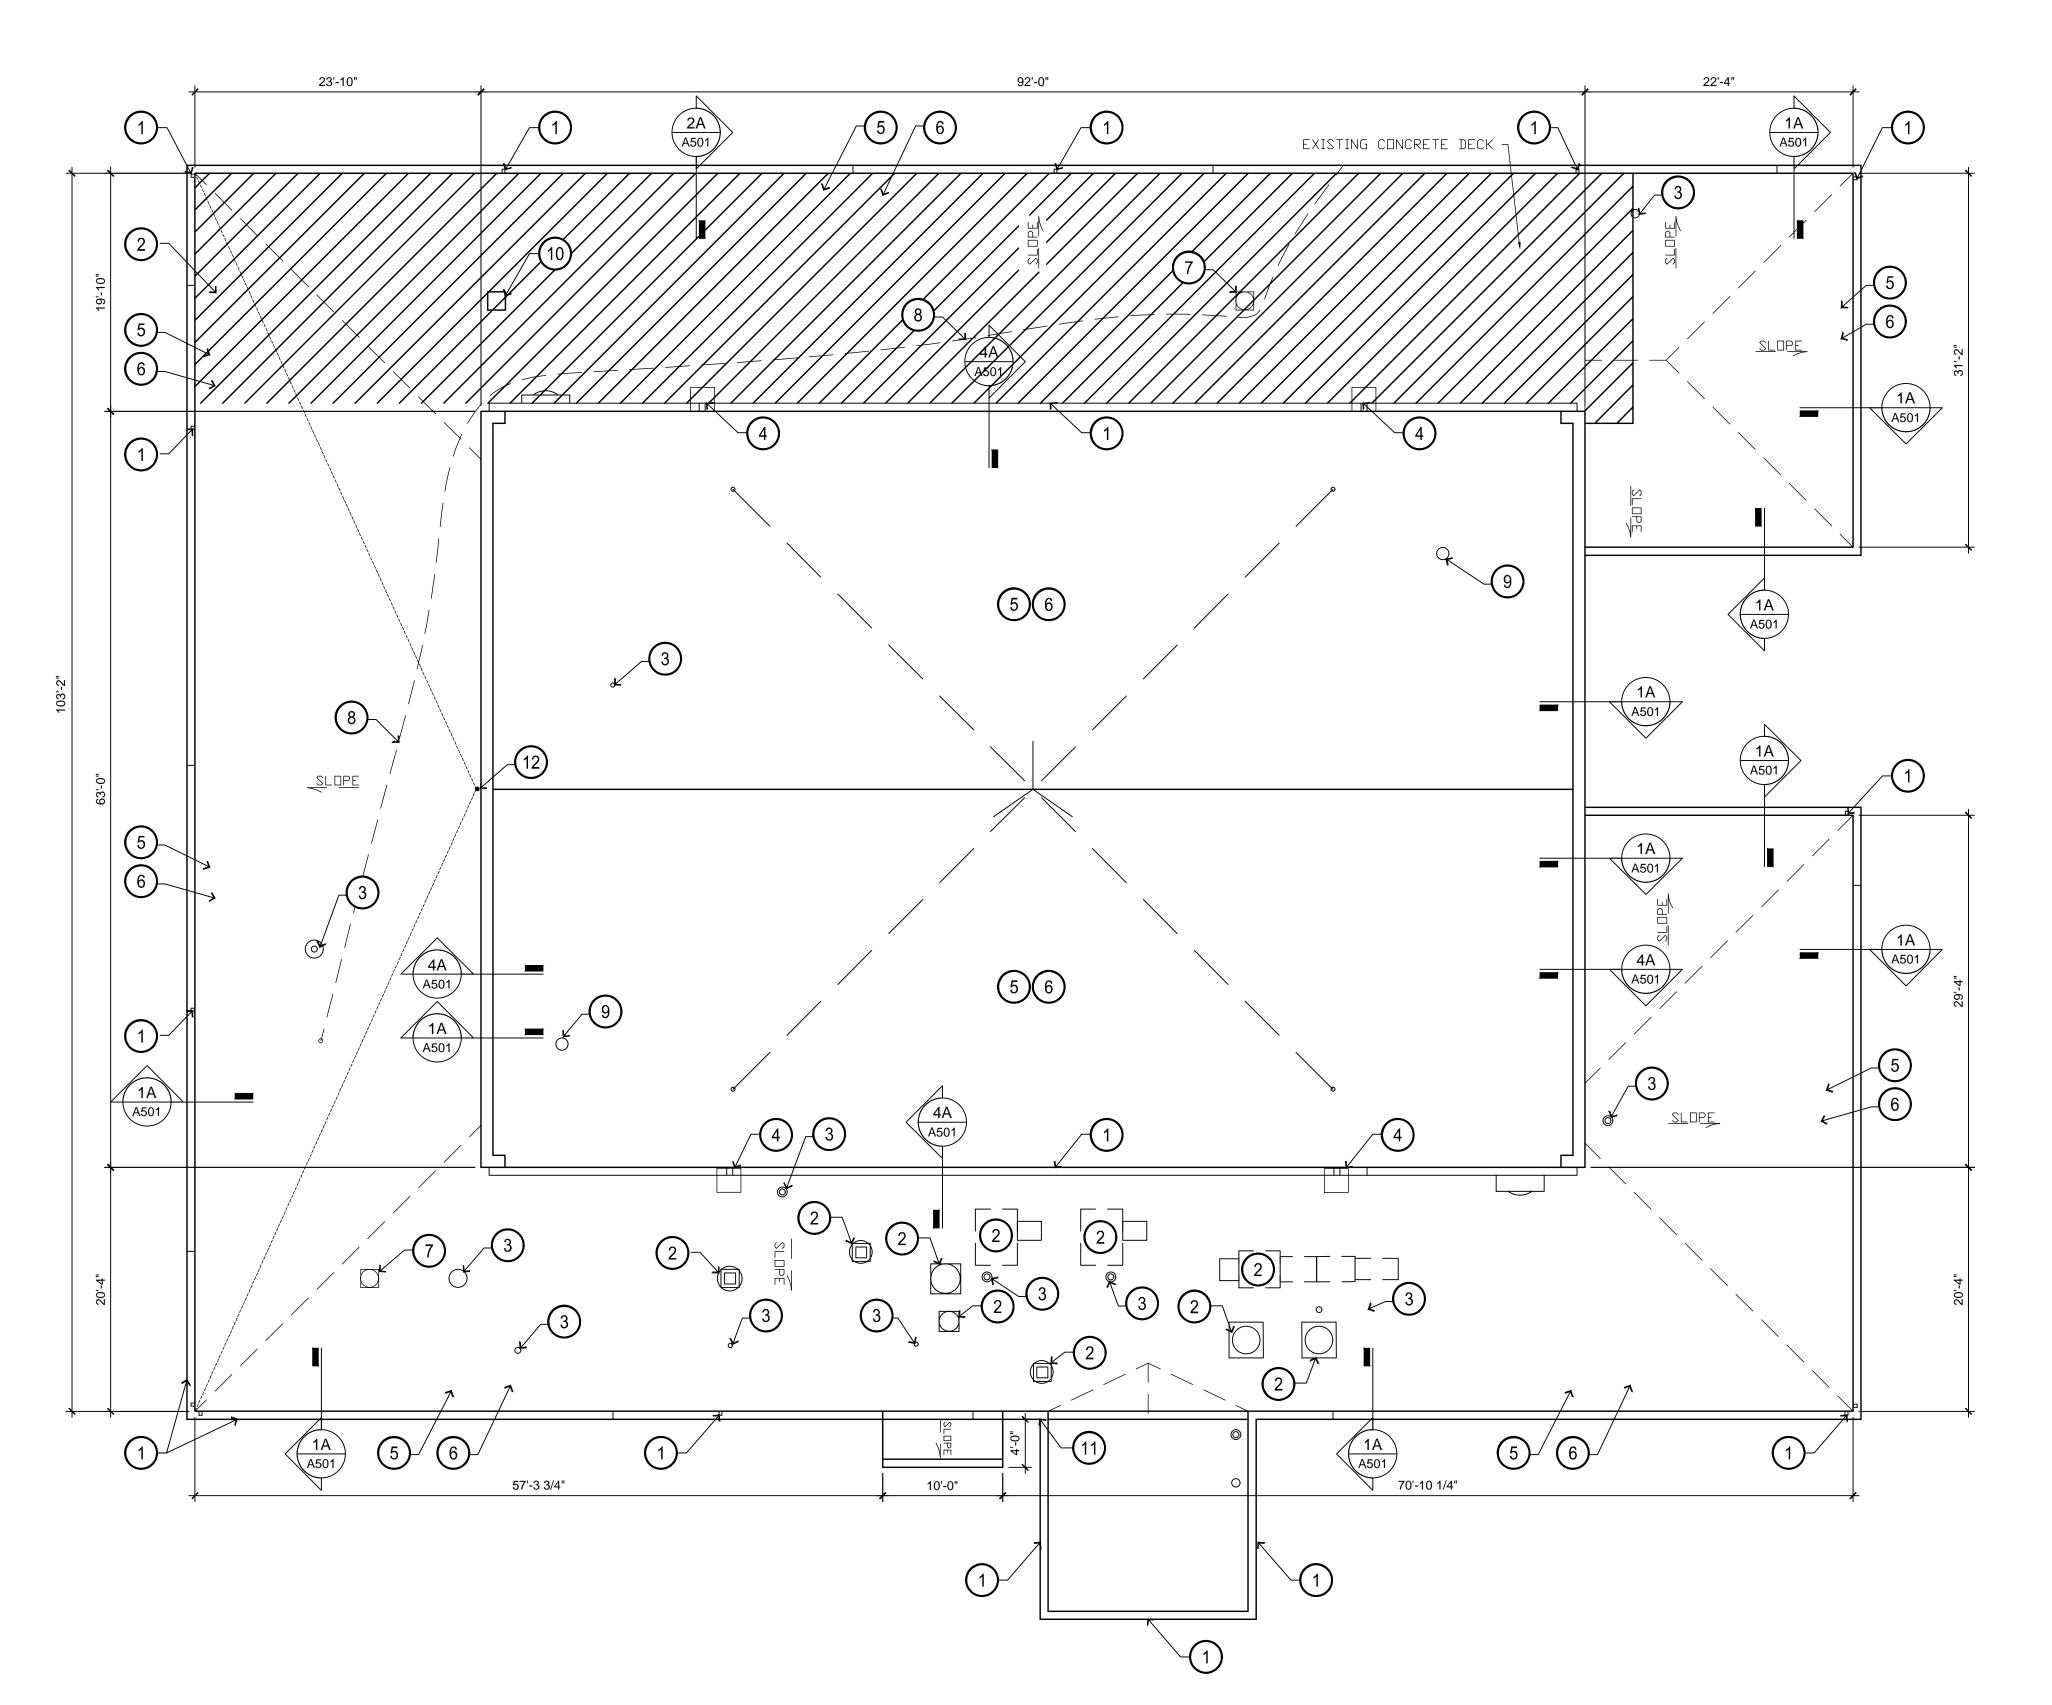
FLOOR PLAN -DEMO

SHEET NUMBER:



August 1, 2019

1 FLOOR PLAN DEMO
SCALE: 1/8" = 1'-0"



#### **GENERAL NOTES:**

- 1. CONTRACTOR SHALL FIELD VERIFY ALL BUILDING CONDITIONS AND DIMENSIONS
- 2. THE CONSTRUCTION DETAILS ON THE FOLLOWING SHEETS ARE FOR REFERENCE ONLY
- 3. THE TAPERED INSULATION LAYOUT IS FOR REFERENCE ONLY. THE SUBMITTED TAPERED LAYOUT
- MUST MEET ASHRAE REQUIREMENTS BASED ON STATE OF MISSOURI ROOF PROJECT MANUAL.

  4. THE NEW ROOF SHALL HAVE A MINIMUM SLOPE OF 1/4" PER FOOT UNLESS NOTED OTHERWISE
- THE NEW ROOF SHALL HAVE A 15 YEAR WARRANTY.
- 6. EXISTING ROOFING AND INSULATION SHALL BE REMOVED DOWN TO THE EXISTING
  - METAL/CONCRETE DECK AND REPLACED WITH TAPERED INSULATION AND FULLY ADHERED TPO SINGLE PLY ROOF MEMBRANE.
- EXISTING ANTENNA TO BE REMOVED.
- 8. THE CAULKING, GLAZING, AND ROOFING MATERIALS CONTAIN ASBESTOS. TESTING PENDING.
- 1/2" PER 1" SLOPE CRICKETS, REQUIRES TO SHED WATER AT MECHANICAL UNITS, REFERENCE STATE OF MISSOURI ROOF PROJECT MANUAL

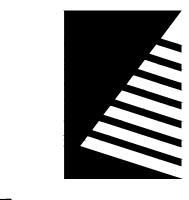
#### KEYNOTES

- 1) REMOVE EXISTING ROOF GUTTER AND DOWNSPOUT ASSEMBLY.
- 2 DISCONNECT AND TEMPORARILY REMOVE EXISTING MECHANICAL UNIT OR FAN ASSEMBLY ATOP CURB TO ACCOMMODATE NEW WORK. SEE DETAIL 3A/A501 FOR CURB DEMO INFORMATION.
- 3 PROTECT EXISTING PIPING THRU ROOF
- (4) REMOVE DOWNSPOUT SPLASHPAD.
- (5) REMOVE EXISTING INSULATION.
- (6) REMOVE EXISTING MEMBRANE ROOF ASSEMBLY.
- 7) REMOVE EXISTING EQUIPMENT.
- 8 REMOVE EXISTING COAX CABLE.
- 9 REINSTALL PIPING AS REQUIRED FOR EXISTING HEATERS.
- (10) REMOVE EXISTING ROOF POP-UP AND PATCH HOLE.
- (11) REMOVE DOWNSPOUT
- (12) REMOVE EXISTING ANTENNA AND ALL ASSOCIATED ITEMS

STATE OF MISSOURI MICHAEL L. PARSON, GOVERNOR



EXP: 12/31/20



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ASSET#

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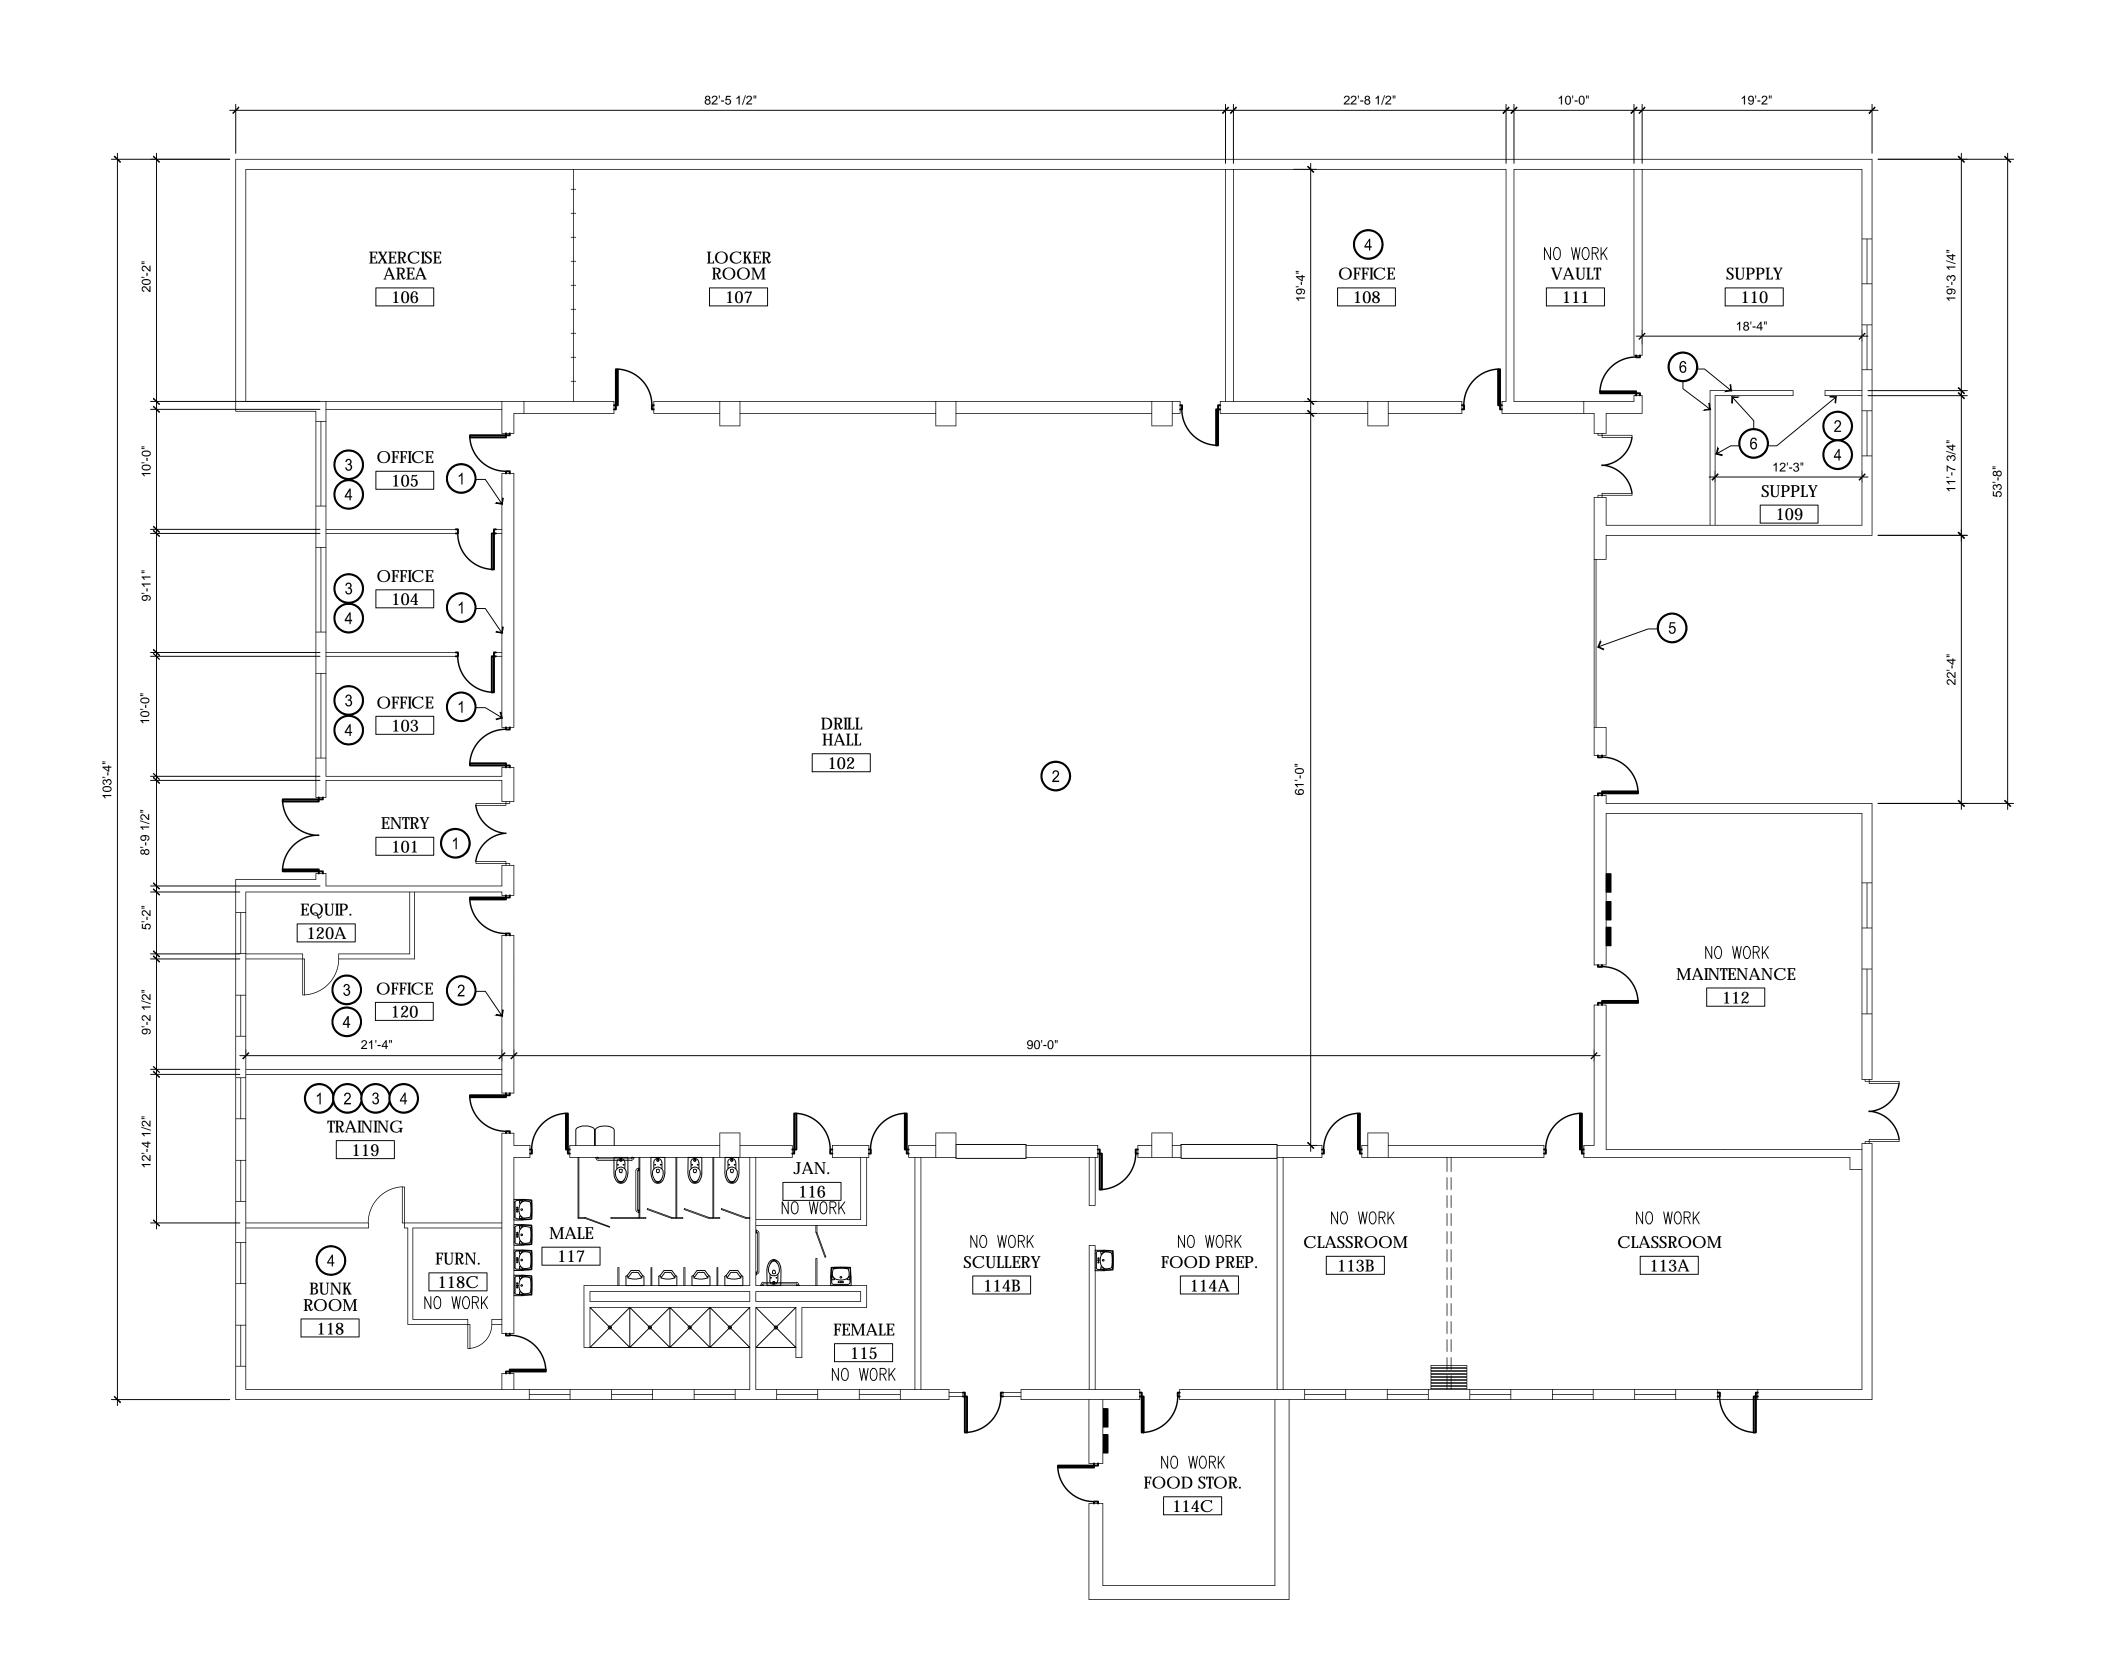
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ROOF PLAN -DEMO

SHEET NUMBER:

A10








#### KEYNOTES

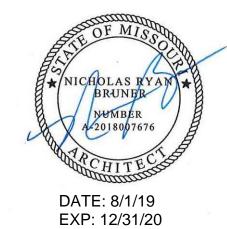- 1) INSTALL GYP. BD. UP TO 2'-0"
- 2 PAINT WALL SEE INTERIOR DRAWINGS
- (3) INSTALL NEW WALL BASE SEE INTERIOR DRAWINGS
- (4) INSTALL NEW FLOORING SEE INTERIOR DRAWINGS
- (5) INSTALL NEW GARAGE DOOR AND DOOR OPENER
- 6 REINSTALL OR REPLACE PANELING

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PROJECT # T1931-01 SITE # 6312 ASSET # 012621200

8136312001

REVISION:
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ISSUE DATE: 08/01/2019

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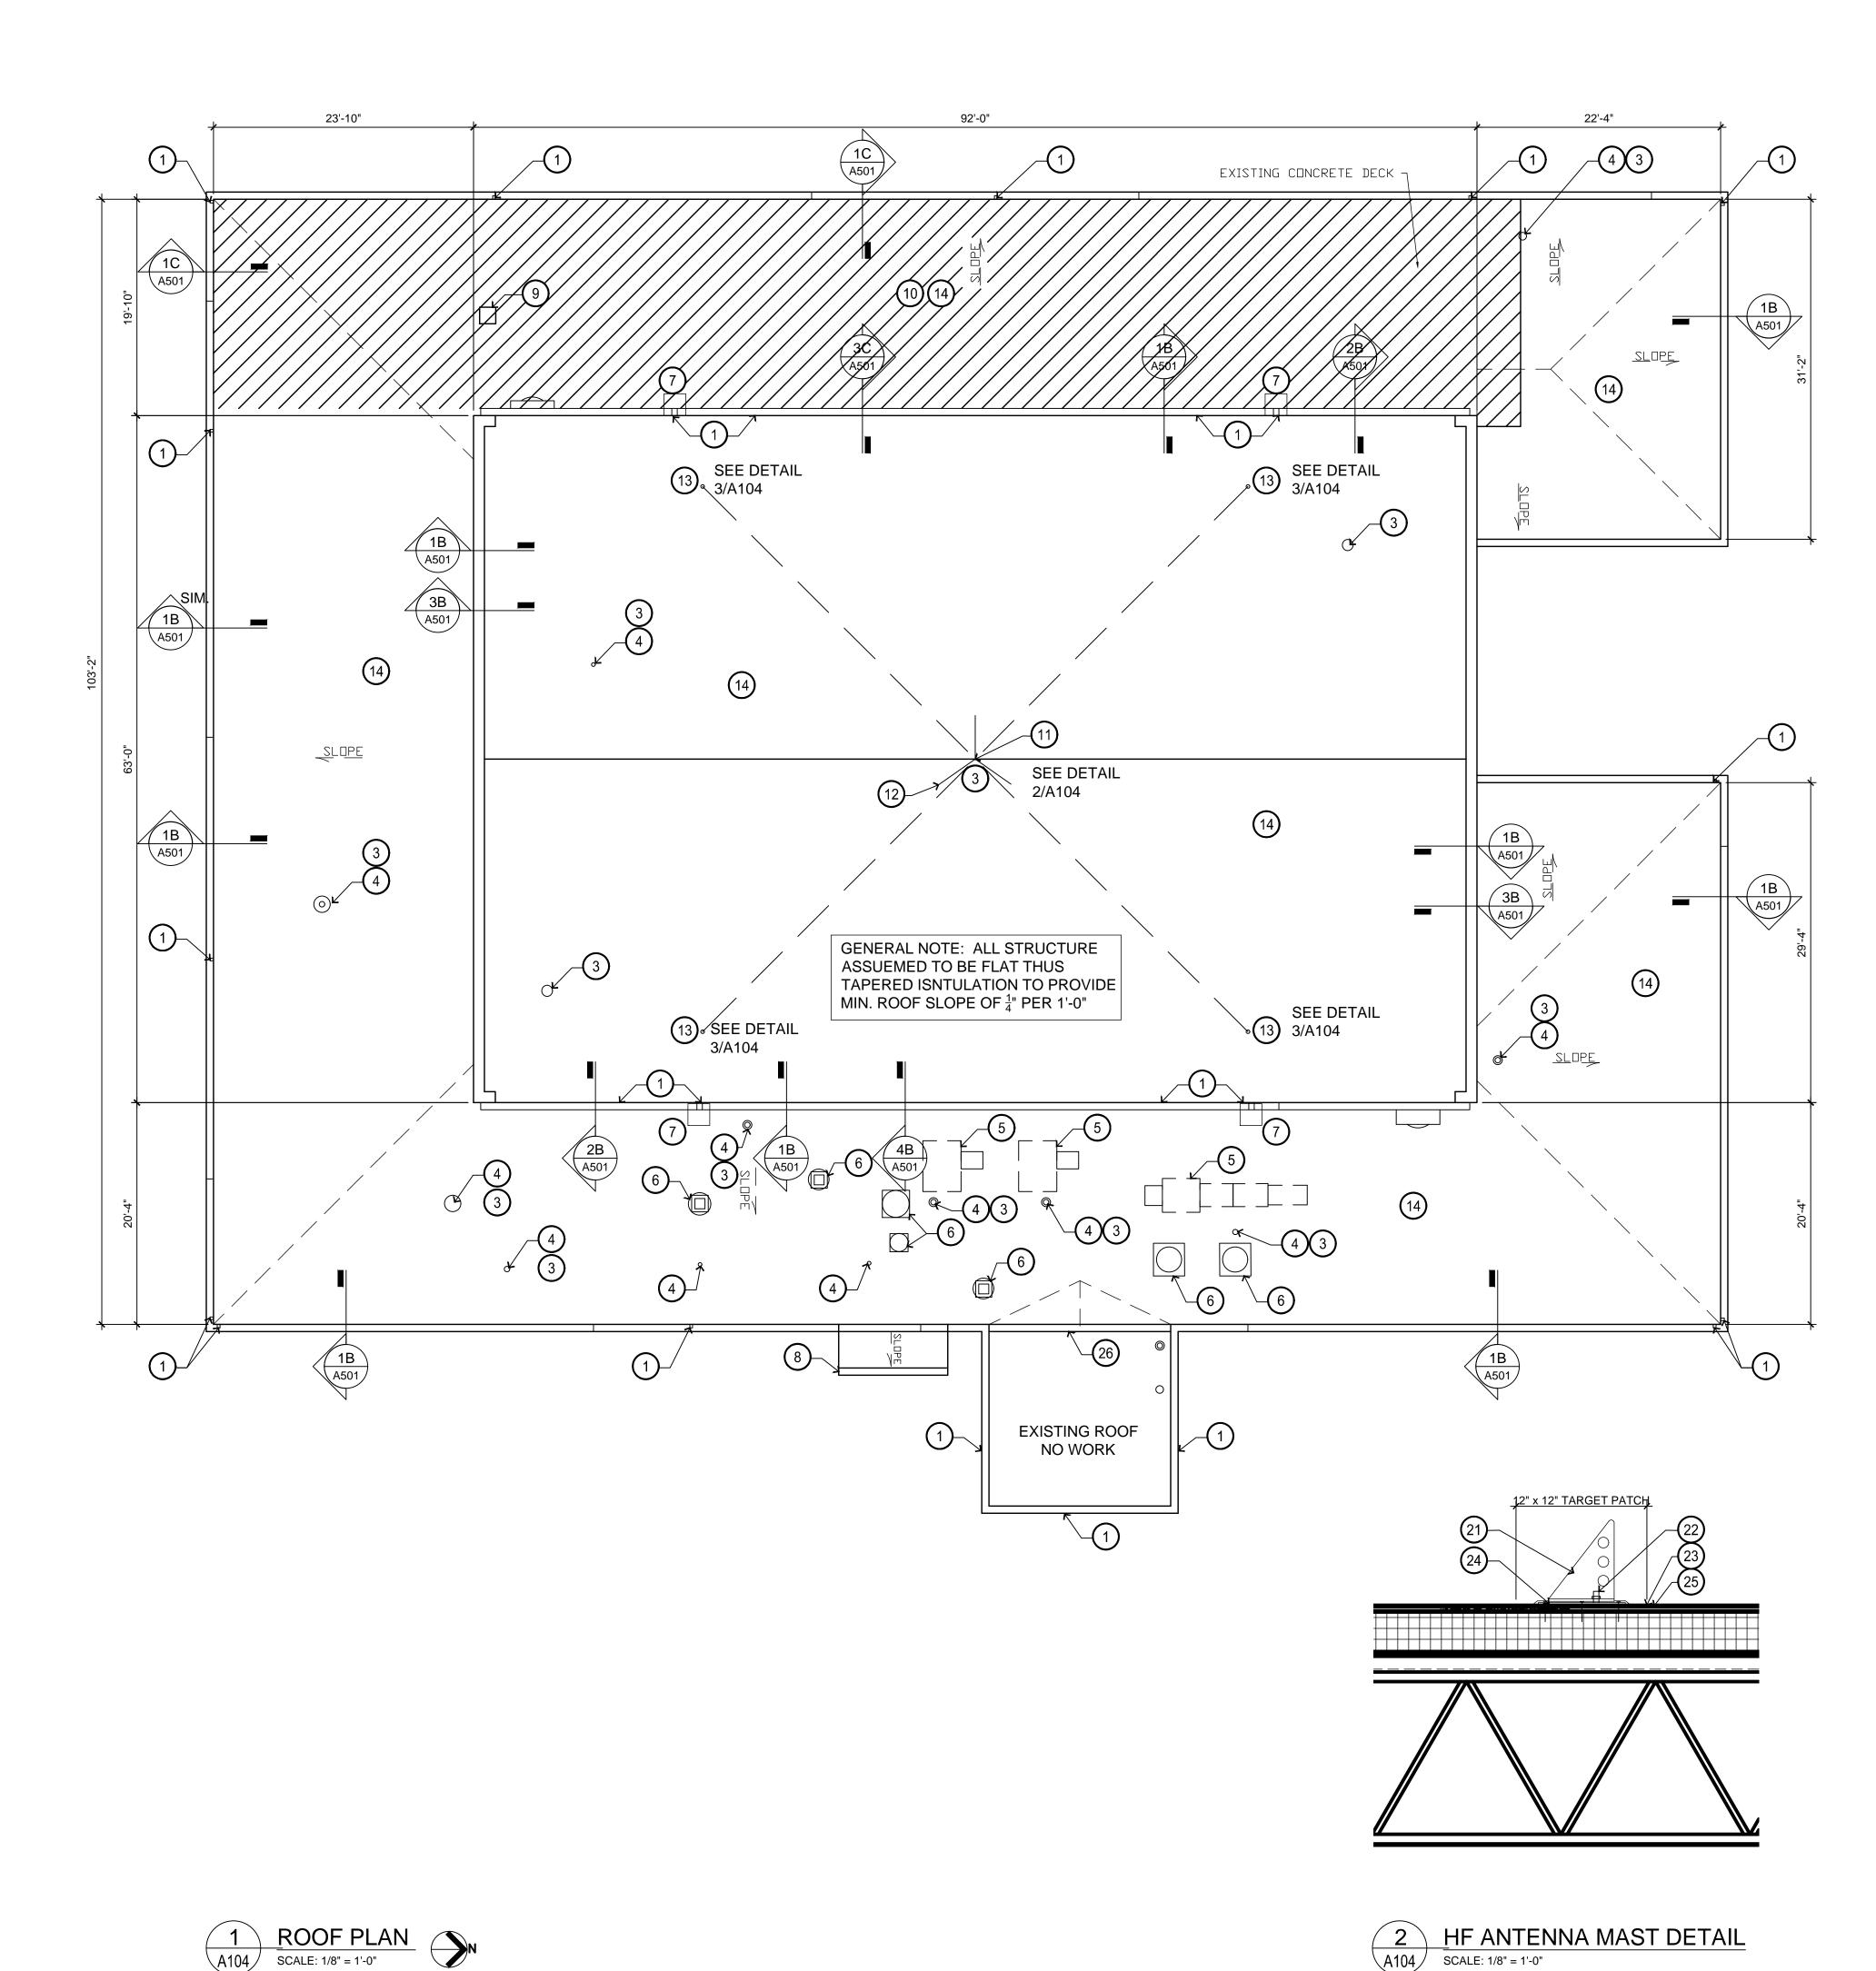
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FLOOR PLAN


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A103






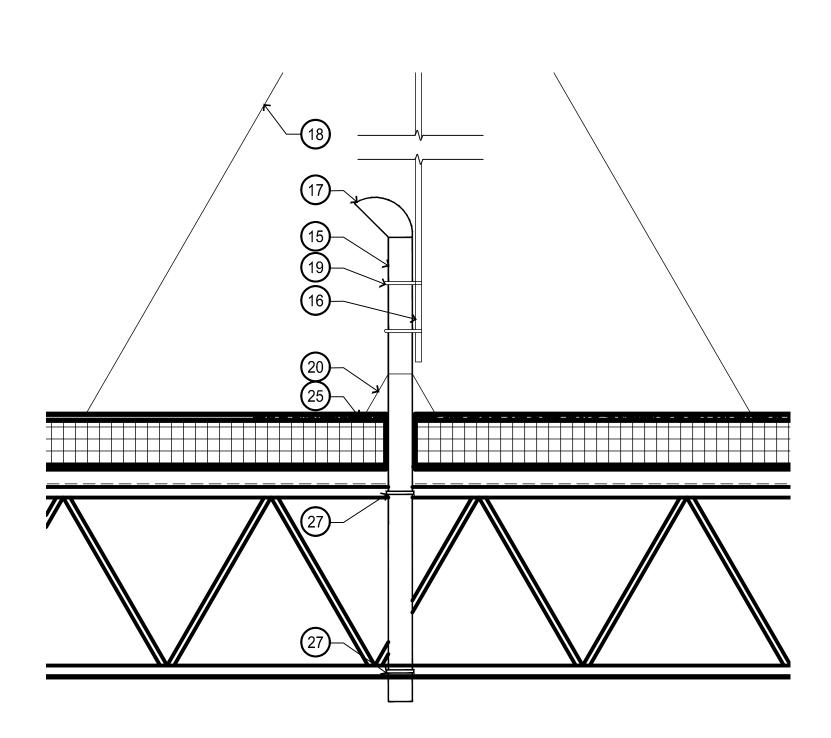
- 1) NEW GUTTER AND DOWNSPOUT ASSEMBLY MATCH EXISTING
- (2) EXISTING MECHANICAL UNIT ASSEMBLY ATOP CURB
- 3 NEW PIPE SEAL AT EXISTING PIPING THRU ROOF
- 4 EXISTING PIPING THRU ROOF
- 5 REINSTALL EXISTING MECHANICAL UNIT ASSEMBLY ATOP NEW ROOFING OVER CURB.
- 6 REINSTALL EXISTING EXHAUST FAN ASSEMBLY ATOP NEW ROOFING OVER CURB
- (7) NEW DOWNSPOUT PRE-CAST CONCRETE SPLASHPAD
- 8 PROTECT EXISTING ROOF GUTTER AND DOWNSPOUT ASSEMBLY TO REMAIN
- 9 INFILL EXISTING ROOF POP-UP
- 10 HATCH INDICATES CONCRETE DECK ABOVE VAULT AREA BELOW (FIELD VERIFY) PROTECT EXISTING CONCRETE
  - 11) 1" DIA. 12'-0" ALUM. ANTENNA POLE, NEW PIPE SEAL, INSTALL PER MANUFACTURER'S INSTRUCTIONS
  - 12) GUY WIRE ANCHORS SPACED EVENLY FROM CENTER ON 4' RADIUS ANCHOR TO STRUCTURE - INSTALL PER OWNER'S INSTRUCTIONS
  - (13) ANTENNA ANCHORS SPACED EVENLY ANCHOR TO STRUCTURE
  - 14) NEW FULLY ADHERED TPO ROOFING ASSEMBLY
  - 15) 2" GALV. STEEL PIPE
  - 16 1" ALUM. POLE
  - (17) WEATHER HEAD
  - 18) GUY WIRE
  - (19) STAINLESS STEEL PIPE CLAMPS
  - 20 BOOT/FLASH COMPATIBLE WITH ROOF MATERIAL
  - 21) STAINLESS STEEL BRACKET
  - 22) THREADED BOLT W/ NEOPRENE WASHER AND NUT
  - 23 MANUFACTURER ACCEPTABLE SEALANT (TYP.)
  - 24) STAINLESS STEEL BASE PLATE
  - (25) ROOF MEMBRANE
  - (26) EXISTING ROOF CRICKET TO BE REPLACED TIE NEW ROOFING INTO EXISTING EXPANSION JOINT
  - (27) SECURE WITH U-CLAMPS AT TOP AND BOTTOM OF BAR JOIST





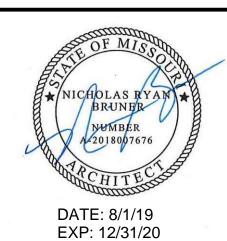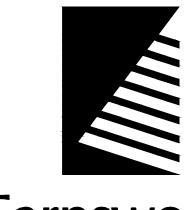STATE OF MISSOURI MICHAEL L. PARSON, **GOVERNOR** 





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**DEPARTMENT OF PUBLIC SAFETY** MISSOURI NATIONAL **GUARD OFFICE OF THE** ADJUTANT GENERAL **FACILITIES DIVISION** 

REPAIR STORM DAMAGE & REPLACE ROOF

JACKSON READINESS CENTER 224 W PARK ST. JACKSON, MISSOURI 63755

PROJECT # T1931-01 6312 SITE# 8136312001

<b>REVISION:</b>	
DATE:	
REVISION:	
DATE:	
REVISION:	

ASSET#


ISSUE DATE: 08/01/2019

CAD DWG FILE: T1931-01.6312.A104 DRAWN BY: NWK
CHECKED BY: NRB
DESIGNED BY: BTW

SHEET TITLE:

**ROOF PLAN** 

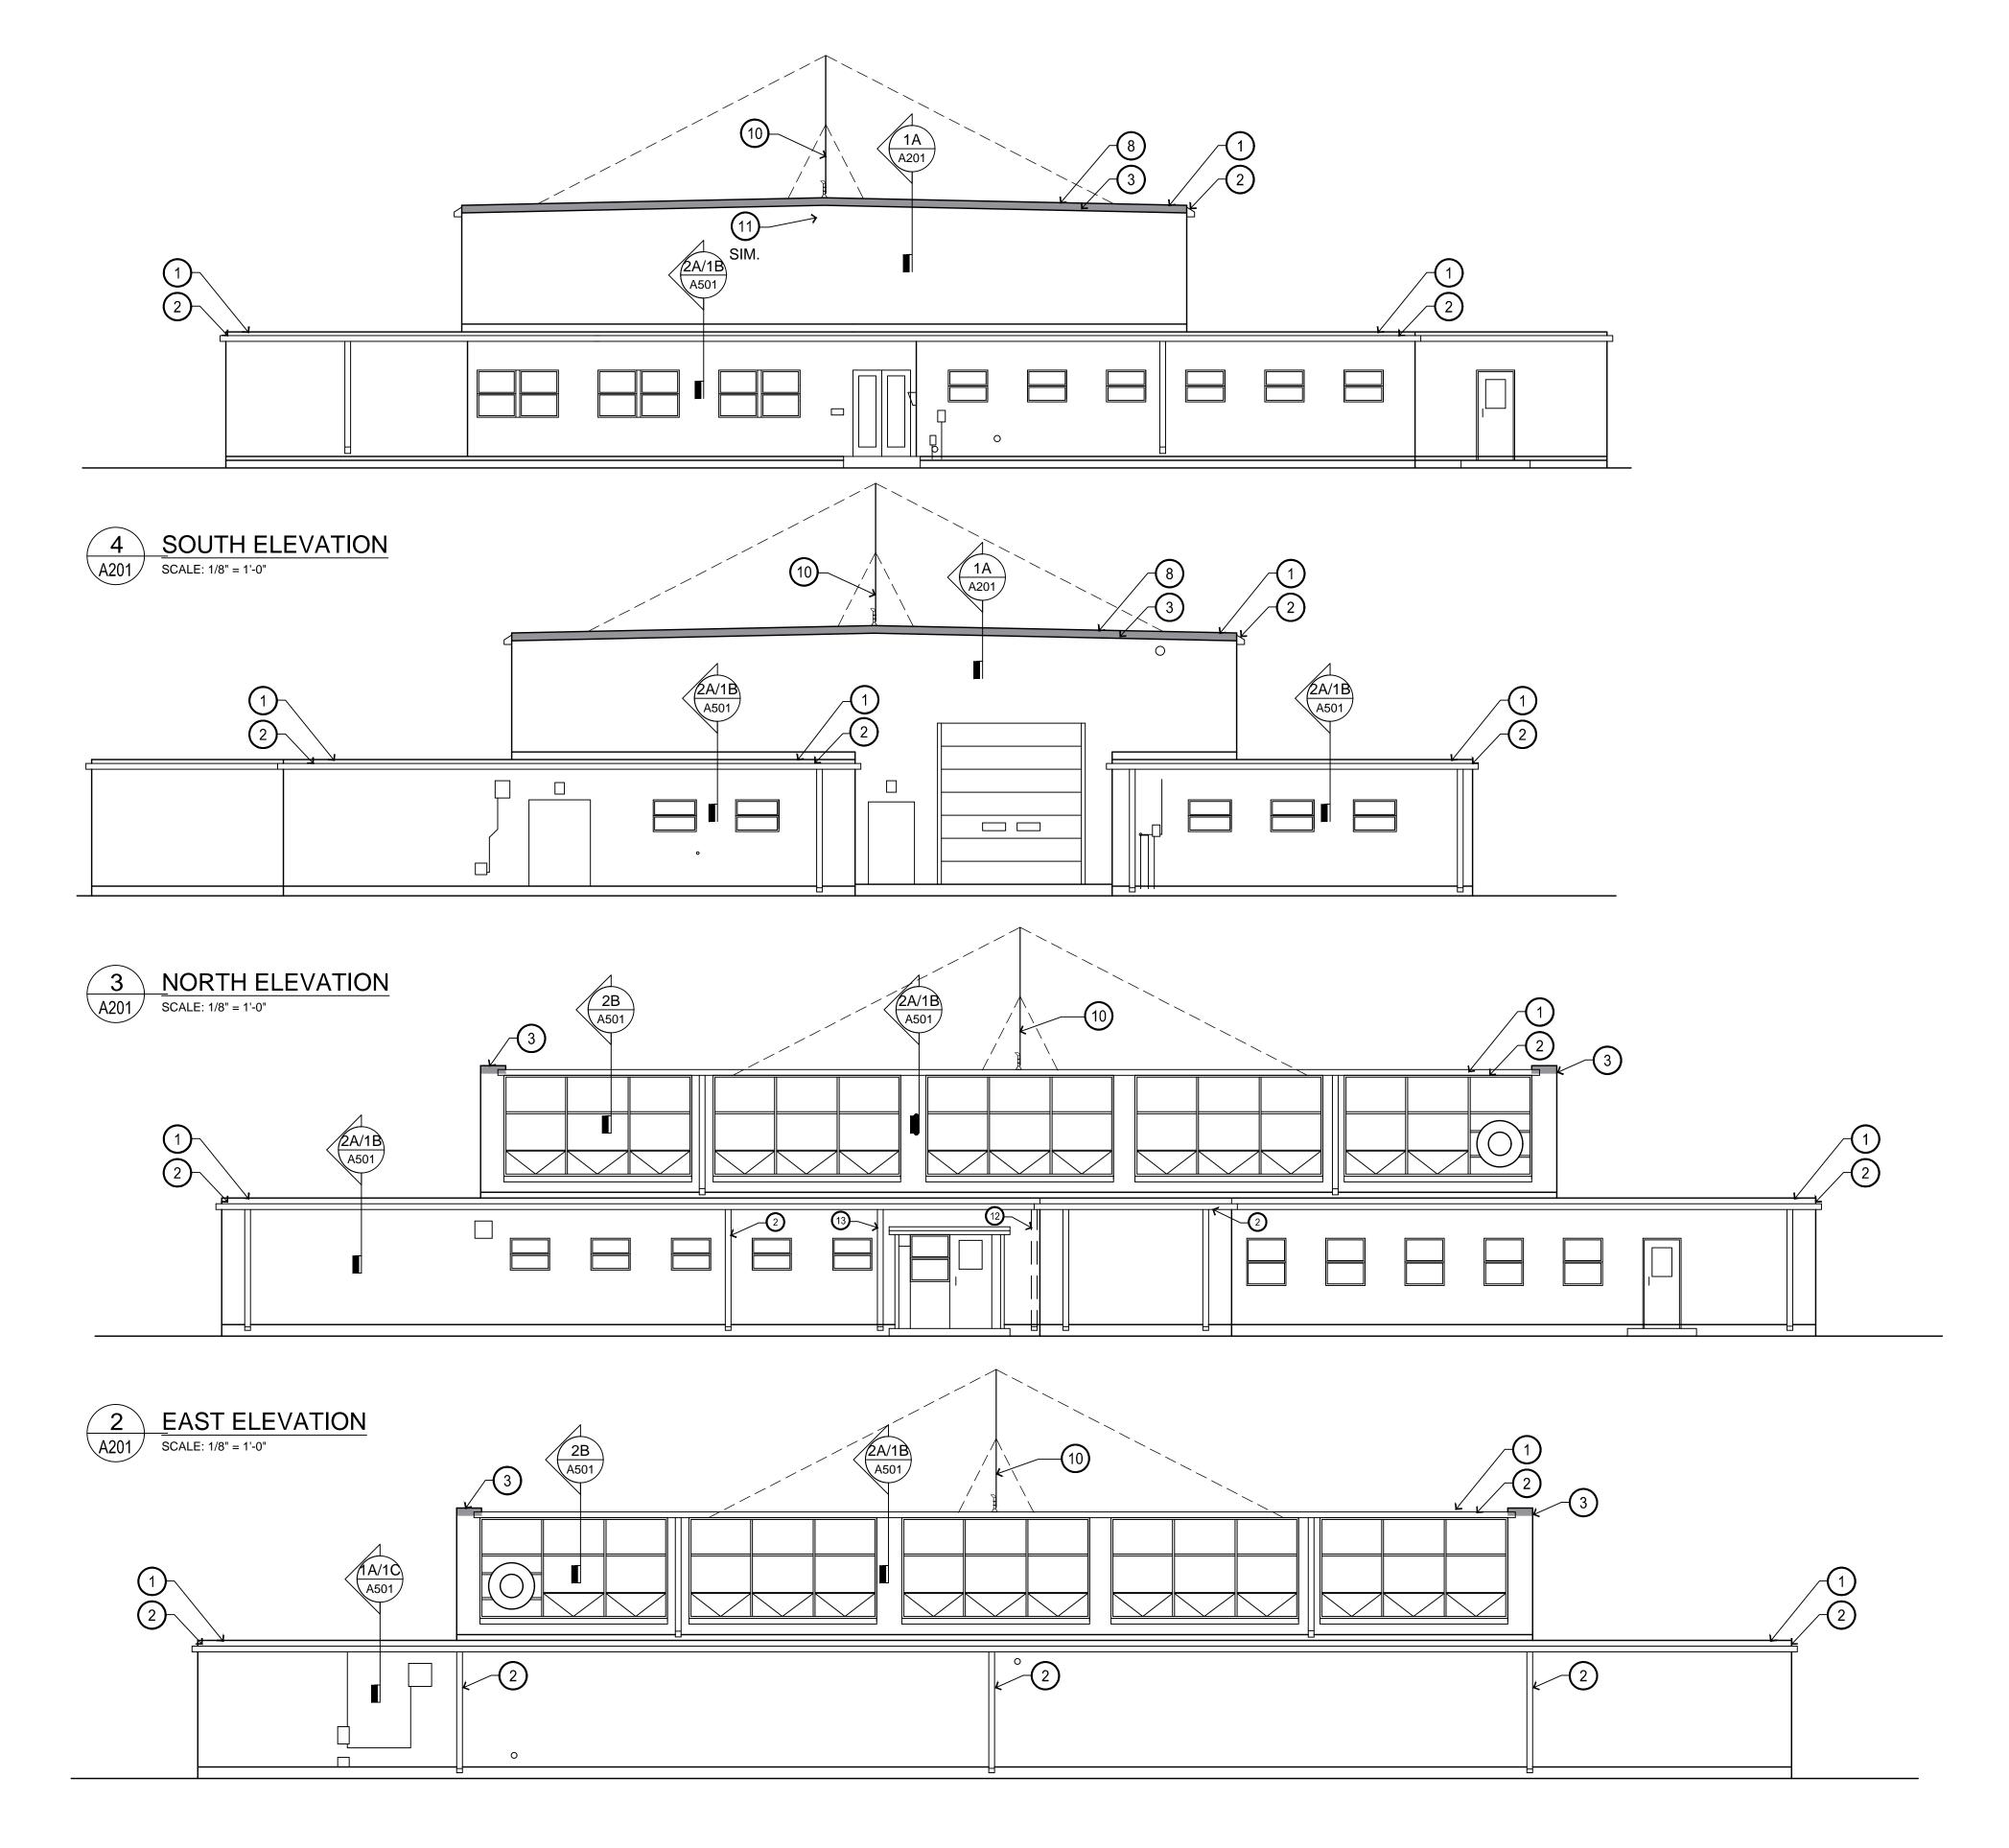
SHEET NUMBER:



### 1 WEST ELEVATION SCALE: 1/8" = 1'-0"

#### KEYNOTES

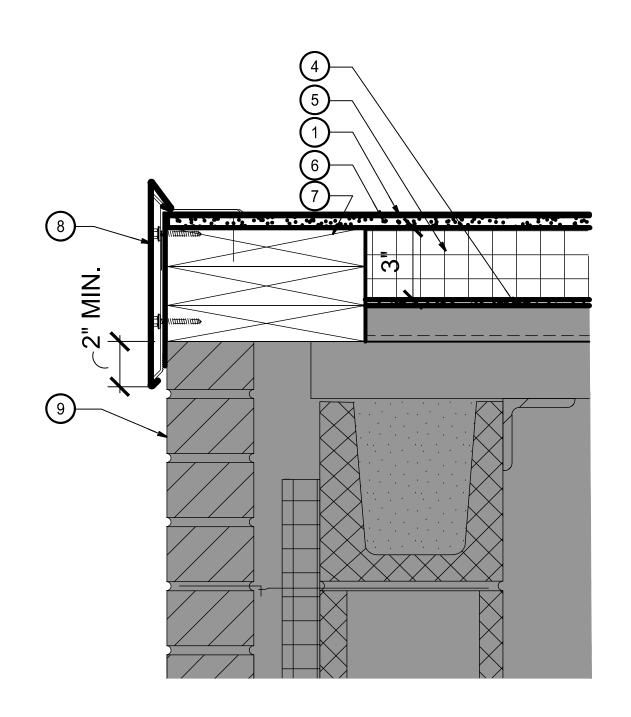- 1) NEW FULLY ADHERED TPO ROOFING ASSEMBLY
- (2) REPLACE EXISTING ROOF GUTTER AND DOWNSPOUT ASSEMBLY
- (3) REPLACED DAMAGED BRICK HATCH INDICATES APPROXIMATE EXTENT OF DAMAGE
- (4) PROTECT EXISTING METAL ROOF DECK
- (5) NEW TAPERED INSULATION 3" MIN. AT ROOF EDGE
- (6) COVER BOARD OVER TAPERED INSULATION ON 1/4" GYP. SHEATHING
- 7 TREATED WOOD BLOCKING. MIN. 2X10 WRAP ALL EXPOSED WOOD WITH METAL CLADDING
- 8 NEW ROOF EDGE COPING
- 9 REPAIR EXISTING BRICK AS REQUIRED REFER TO ELEVATIONS FOR APPROXIMATE EXTENT OF DAMAGE
- (10) NEW ANTENNA SEE DETAILS 2/A104 AND 3/A104
- (11) REMOVE EXISTING ANTENNA, BRACKETS, AND ALL ASSOCIATED ITEMS PATCH MASONRY.
- (12) REMOVE DOWNSPOUT AND RELOCATE
- (13) NEW DOWNSPOUT LOCATION





#### STATE OF MISSOURI MICHAEL L. PARSON, GOVERNOR





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CAD DWG FILE:

T1931-01.6312.A201

DRAWN BY: NWK

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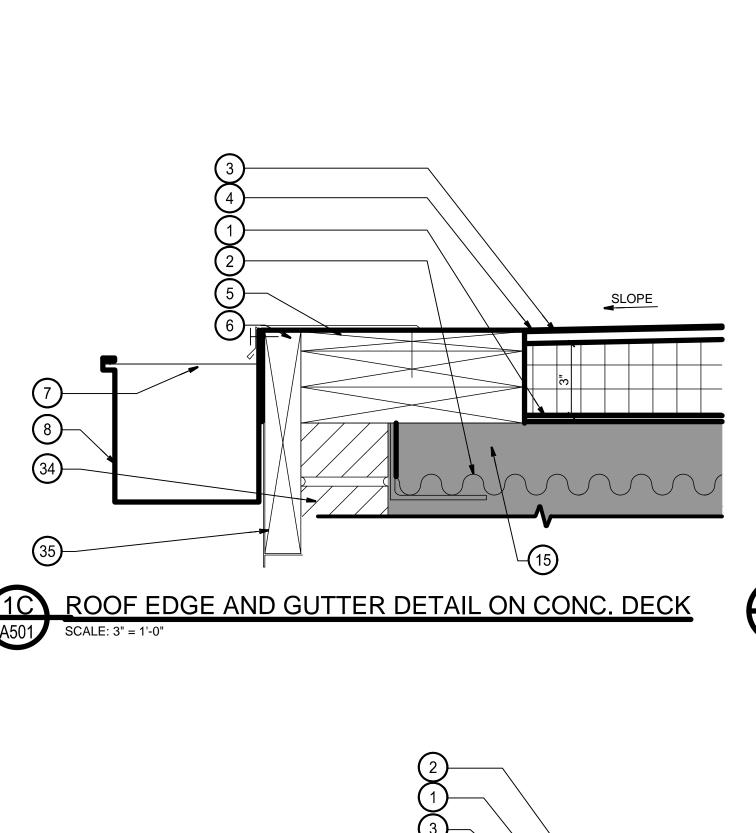
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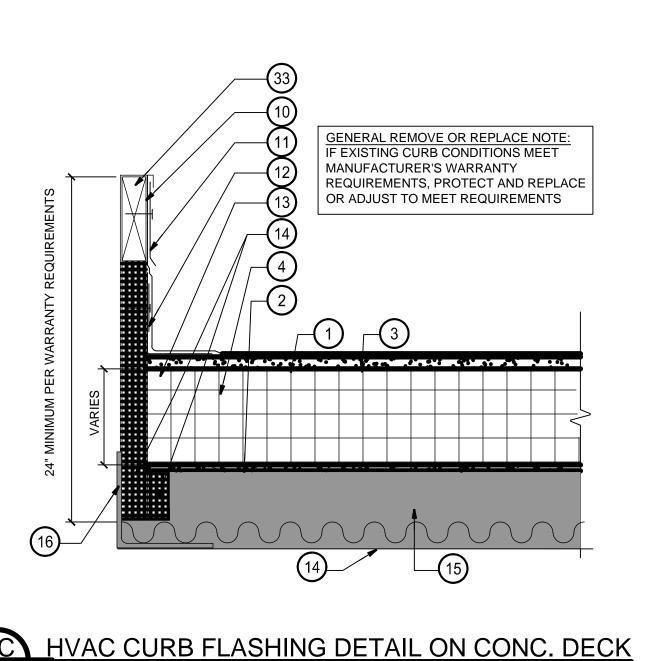
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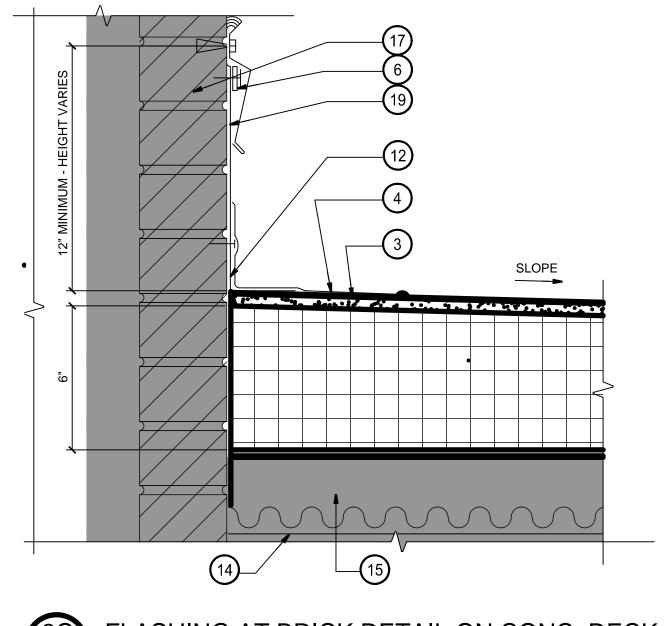
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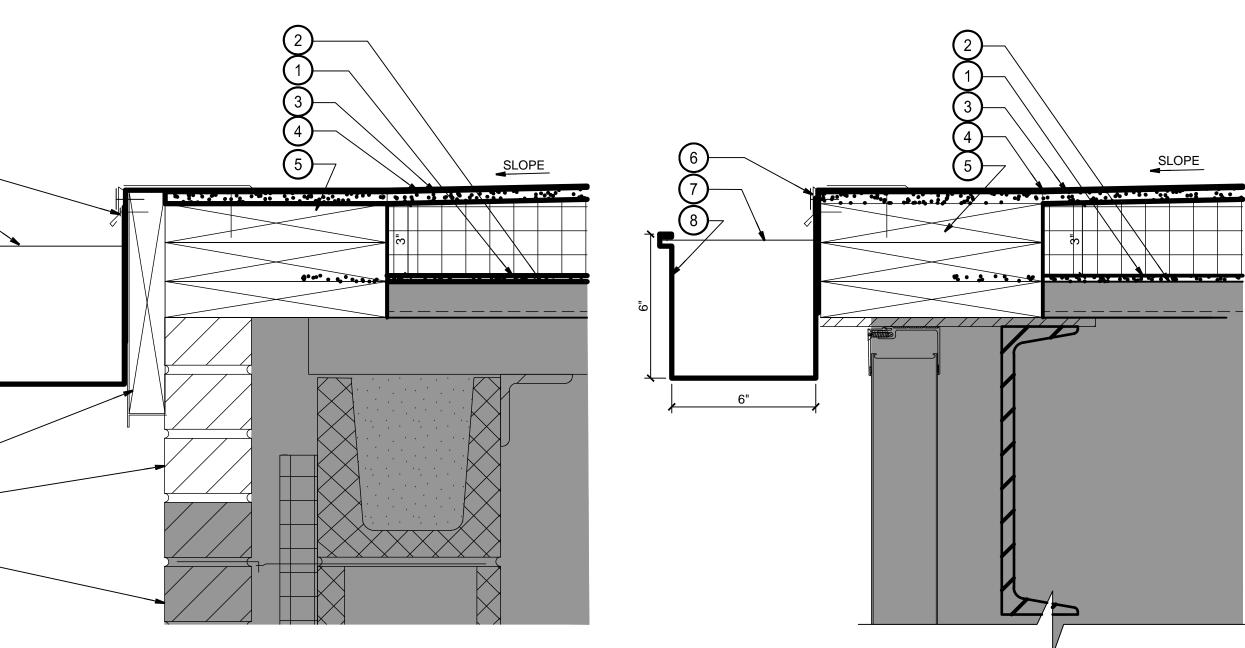
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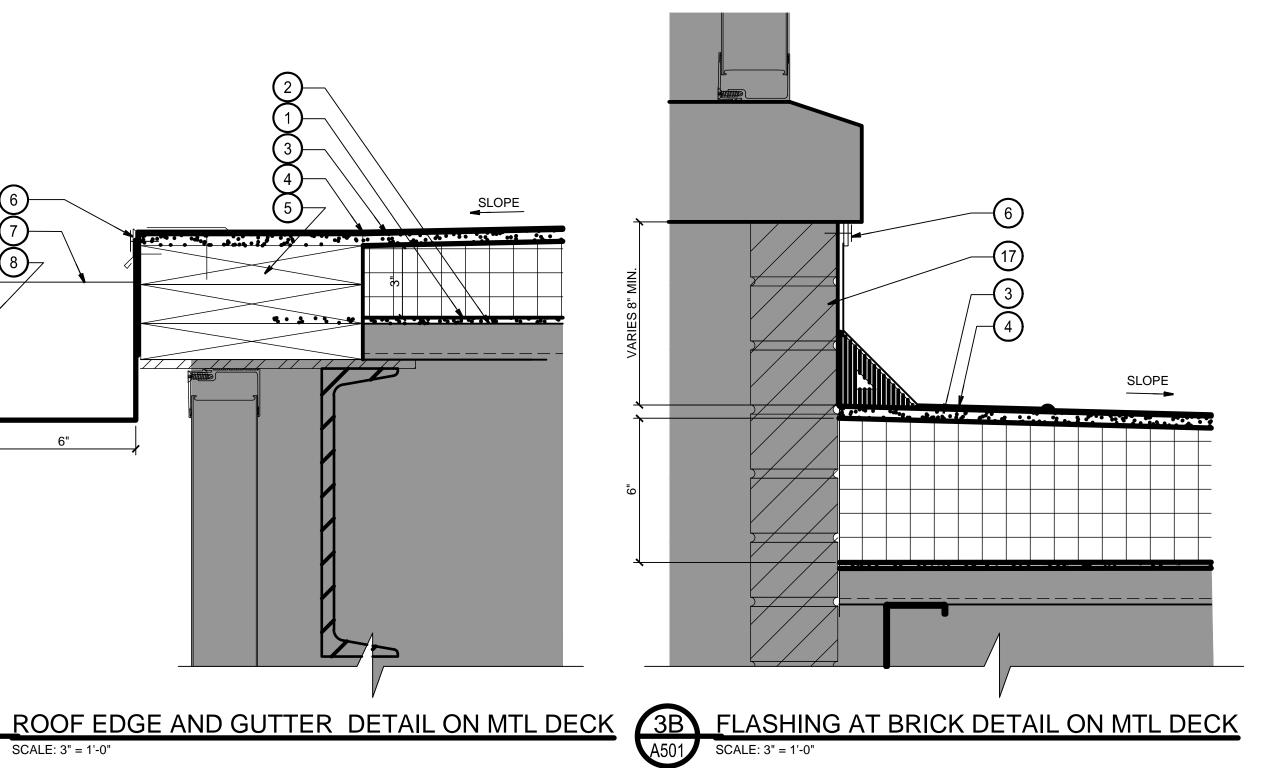


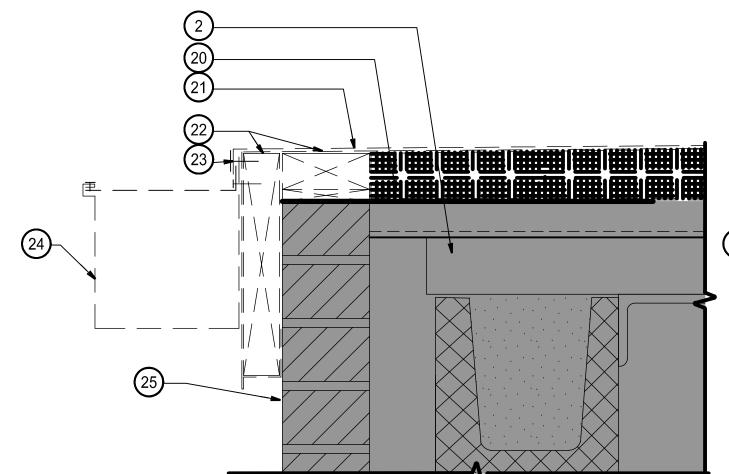













ROOF EDGE AND EXISTING GUTTER DETAIL

(DEMO)

ROOF EDGE AND GUTTER DETAIL ON MTL DECK


(DEMO)

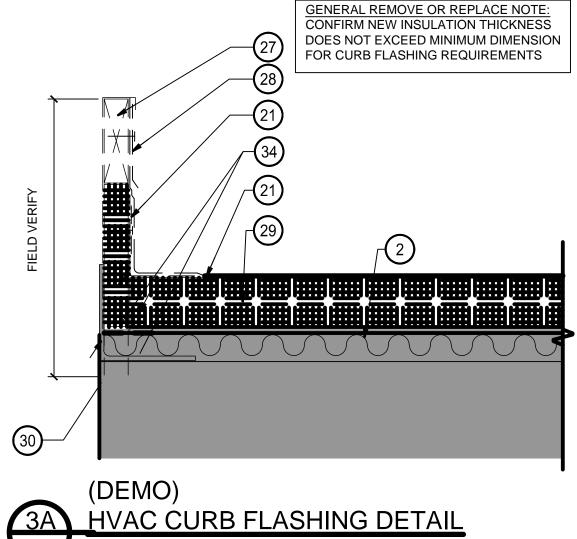ROOF EDGE AND EXISTING GUTTER DETAIL



#### **KEYNOTES**

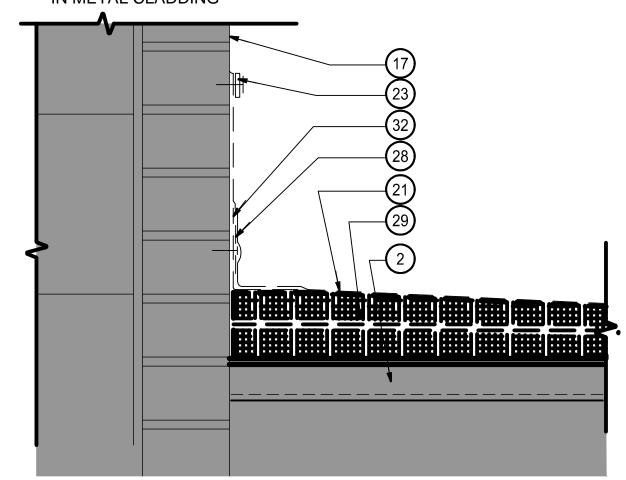- 1) 1/4" GYPSUM SHEATHING (MECHANICALLY FASTENED)
- 2 PROTECT EXISTING TOP OF METAL PAN ON BAR JOIST
- (3) 1/2" COVER BOARD OVER MINIMUM 3" TAPERED INSULATION AT ROOF EDGE
- 4 NEW FULLY ADHERED TPO ROOFING ASSEMBLY
- (5) REPLACE ALL EXISTING WOOD WITH TREATED 2x BLOCKING. ATTACH TO EXISTING STRUCTURE - EXISTING STRUCTURE TO BE FIELD VERIFIED, SEE DETAILS ON SHEET S100 - WRAP ALL EXPOSED WOOD WITH METAL CLADDING
- 6 NEW T-BAR AND SEALANT
- 7) NEW GUTTER STRAP
- (8) NEW METAL GUTTER AND DOWNSPOUT TO MATCH EXISTING SIZE, PROFILE, AND COLOR.
- 9 EXTEND EXISTING METAL CURB (VERIFY HEIGHT ABOVE ROOF REQUIREMENTS WITH HVAC UNIT MANUFACTURERS WARRANTY - ADJUST TO MEET MANUFACTURERS REQUIREMENT)
- (10) REPLACE EXISTING TREATED WOOD NAILER WITH NEW
- (11) NEW GALVANIZED COUNTER FLASHING FASTENED 24" OC
- (12) REINFORCED FASTENING STRIP
- (13) REPLACE EXISTING 1" RIGID INSULATION
- 14) PROTECT TOP OF BAR JOIST
- (15) PROTECT EXISTING CONCRETE
- (16) PROTECT EXISTING 4" STEEL ANGLE
- (17) PROTECT EXISTING BRICK WALL
- (18) NOT USED.
- (19) NEW CONTINUOUS PREFINISHED METAL COUNTERFLASHING
- (20) REMOVE EXISTING INSULATION (MECHANICALLY FASTENED)
- (21) REMOVE EXISTING MEMBRANE ROOF ASSEMBLY
- (22) REMOVE ALL EXISTING WOOD WITH METAL CLADDING
- (23) REMOVE EXISTING T-BAR AND SEALANT
- (24) REMOVE EXISTING METAL GUTTER ASSEMBLY
- 25) PROTECT EXISTING FACE BRICK TO REMAIN
- (26) PROTECT EXISTING CONCRETE
- (27) REMOVE OR REPLACE EXISTING TREATED WOOD NAILER WITH NEW
- (28) REMOVE OR REPLACE EXISTING 2" SEAM PLATE AND FASTENER
- (29) REMOVE EXISTING INSULATION (MECHANICALLY FASTENED)
- (30) PROTECT EXISTING 4" STEEL ANGLE
- (31) REMOVE BLOCKING
- (32) REMOVE REINFORCED FASTENING STRIP
- (33) EXTEND EXISTING METAL CURB TO ACCOMMODATE NEW ROOF INSULATION (VERIFY HEIGH ABOVE ROOF REQUIREMENTS WITH HVAC UNIT MANUFACTURERS WARRANTY - AJUST TO MEET MANUFACTURERS REQUIREMENT)
- REPAIR BRICK AS REQUIRED REFER TO ELEVATIONS ON A-201 FOR APPROXIMATE EXTENT
- (35) REPLACE EXISTING WOOD FASCIA BOARD WITH 2X TREATED WOOD FASCIA BOARD WRAP IN METAL CLADDING






STATE OF MISSOURI MICHAEL L. PARSON, **GOVERNOR** 



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REPAIR STORM DAMAGE & REPLACE ROOF

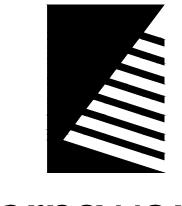**JACKSON** READINESS CENTER 224 W PARK ST. JACKSON, MISSOURI 63755

PROJECT # T1931-01 6312

ASSET#

8136312001

**REVISION:** REVISION:

REVISION: DATE: ISSUE DATE: 08/01/2019

CAD DWG FILE:


T1931-01.6312.A503
DRAWN BY: NWK
CHECKED BY: NRB DESIGNED BY: BTW

SHEET TITLE:

**ROOF DETAILS** 

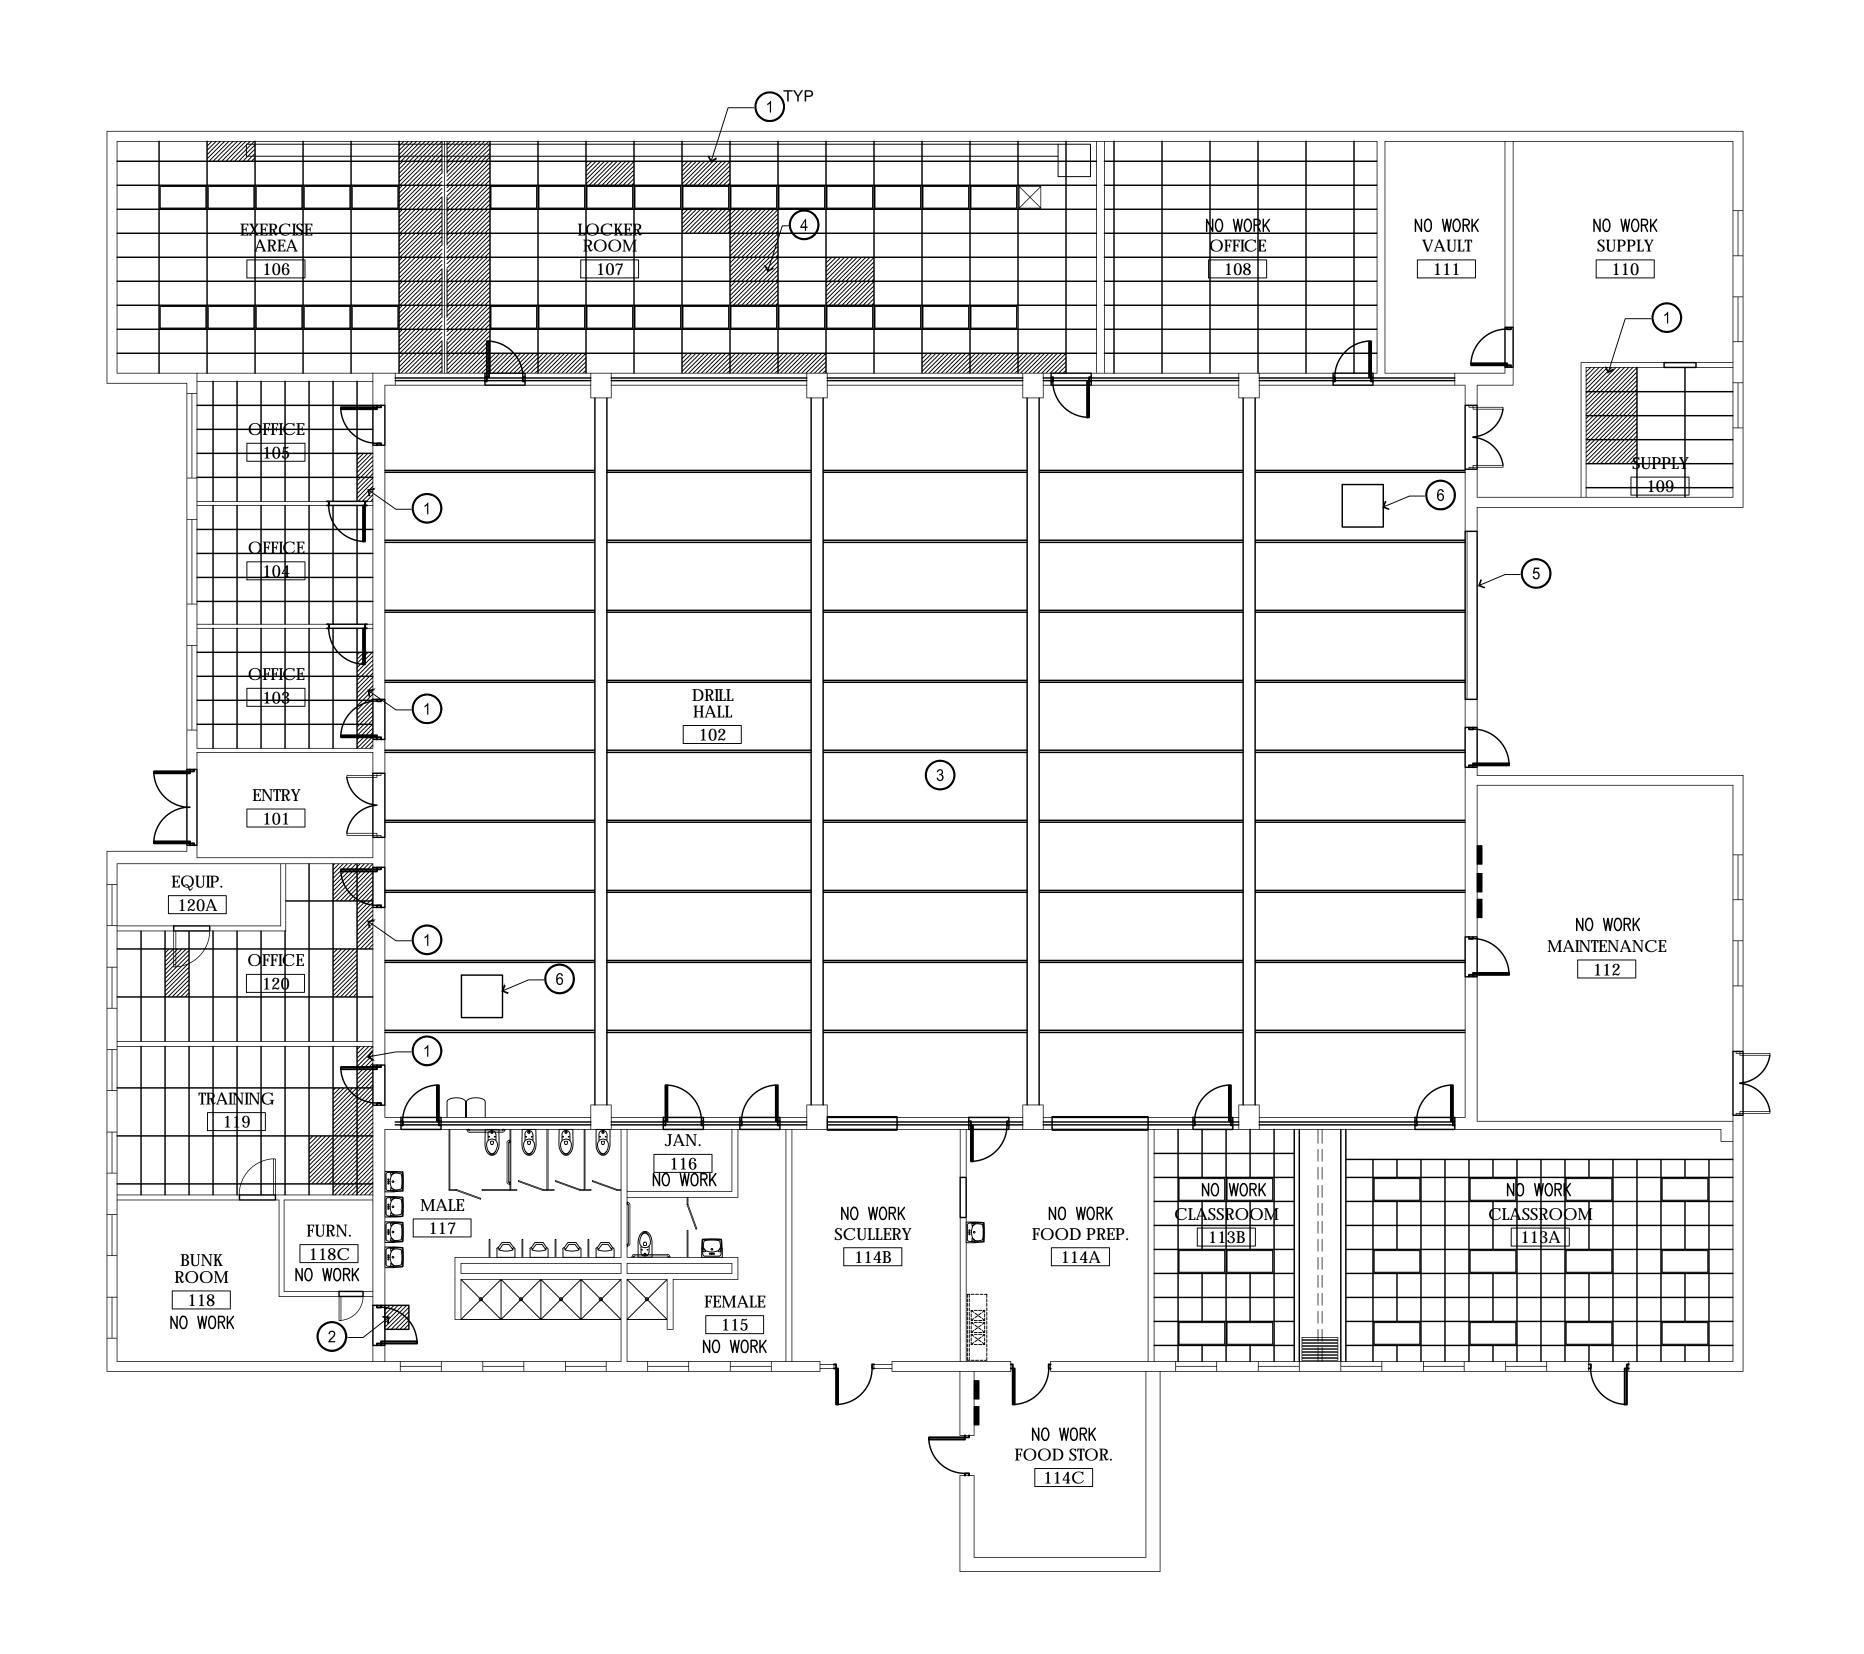SHEET NUMBER:

A501





#### **GENERAL NOTES**

1. REINSTALL ANY CEILING FIXTURES AS REQUIRED BY REPAIR WORK AND REPLACEMENT OF CEILING TILE

#### KEYNOTES

- REPLACE CEILING TILE HATCH INDICATES DAMAGED TILES TO BE REPLACED
- PATCH AND REPAIR HARD CEILING PAINT
- PAINT CEILING/EXPOSED BRICK SEE INTERIOR DRAWINGS
- REINSTALL SMOKE DETECTOR
- INSTALL NEW GARAGE DOOR AND DOOR OPENER
- UNIT HEATER RECONNECT UNIT AND REPLACE FLUE. ROUTE THROUGH EXISTING OPENING IN ROOF DECK ABOVE

STATE OF MISSOURI MICHAEL L. PARSON, **GOVERNOR** 



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**JACKSON** READINESS CENTER 224 W PARK ST. JACKSON, MISSOURI 63755

PROJECT # T1931-01 SITE# 6312 8136312001

ASSET#

**REVISION:** DATE: **REVISION:** DATE: **REVISION:** DATE:

CAD DWG FILE:

T1931-01.6312.A701

DRAWN BY: NWK

CHECKED BY: NRB

DESIGNED BY: BTW

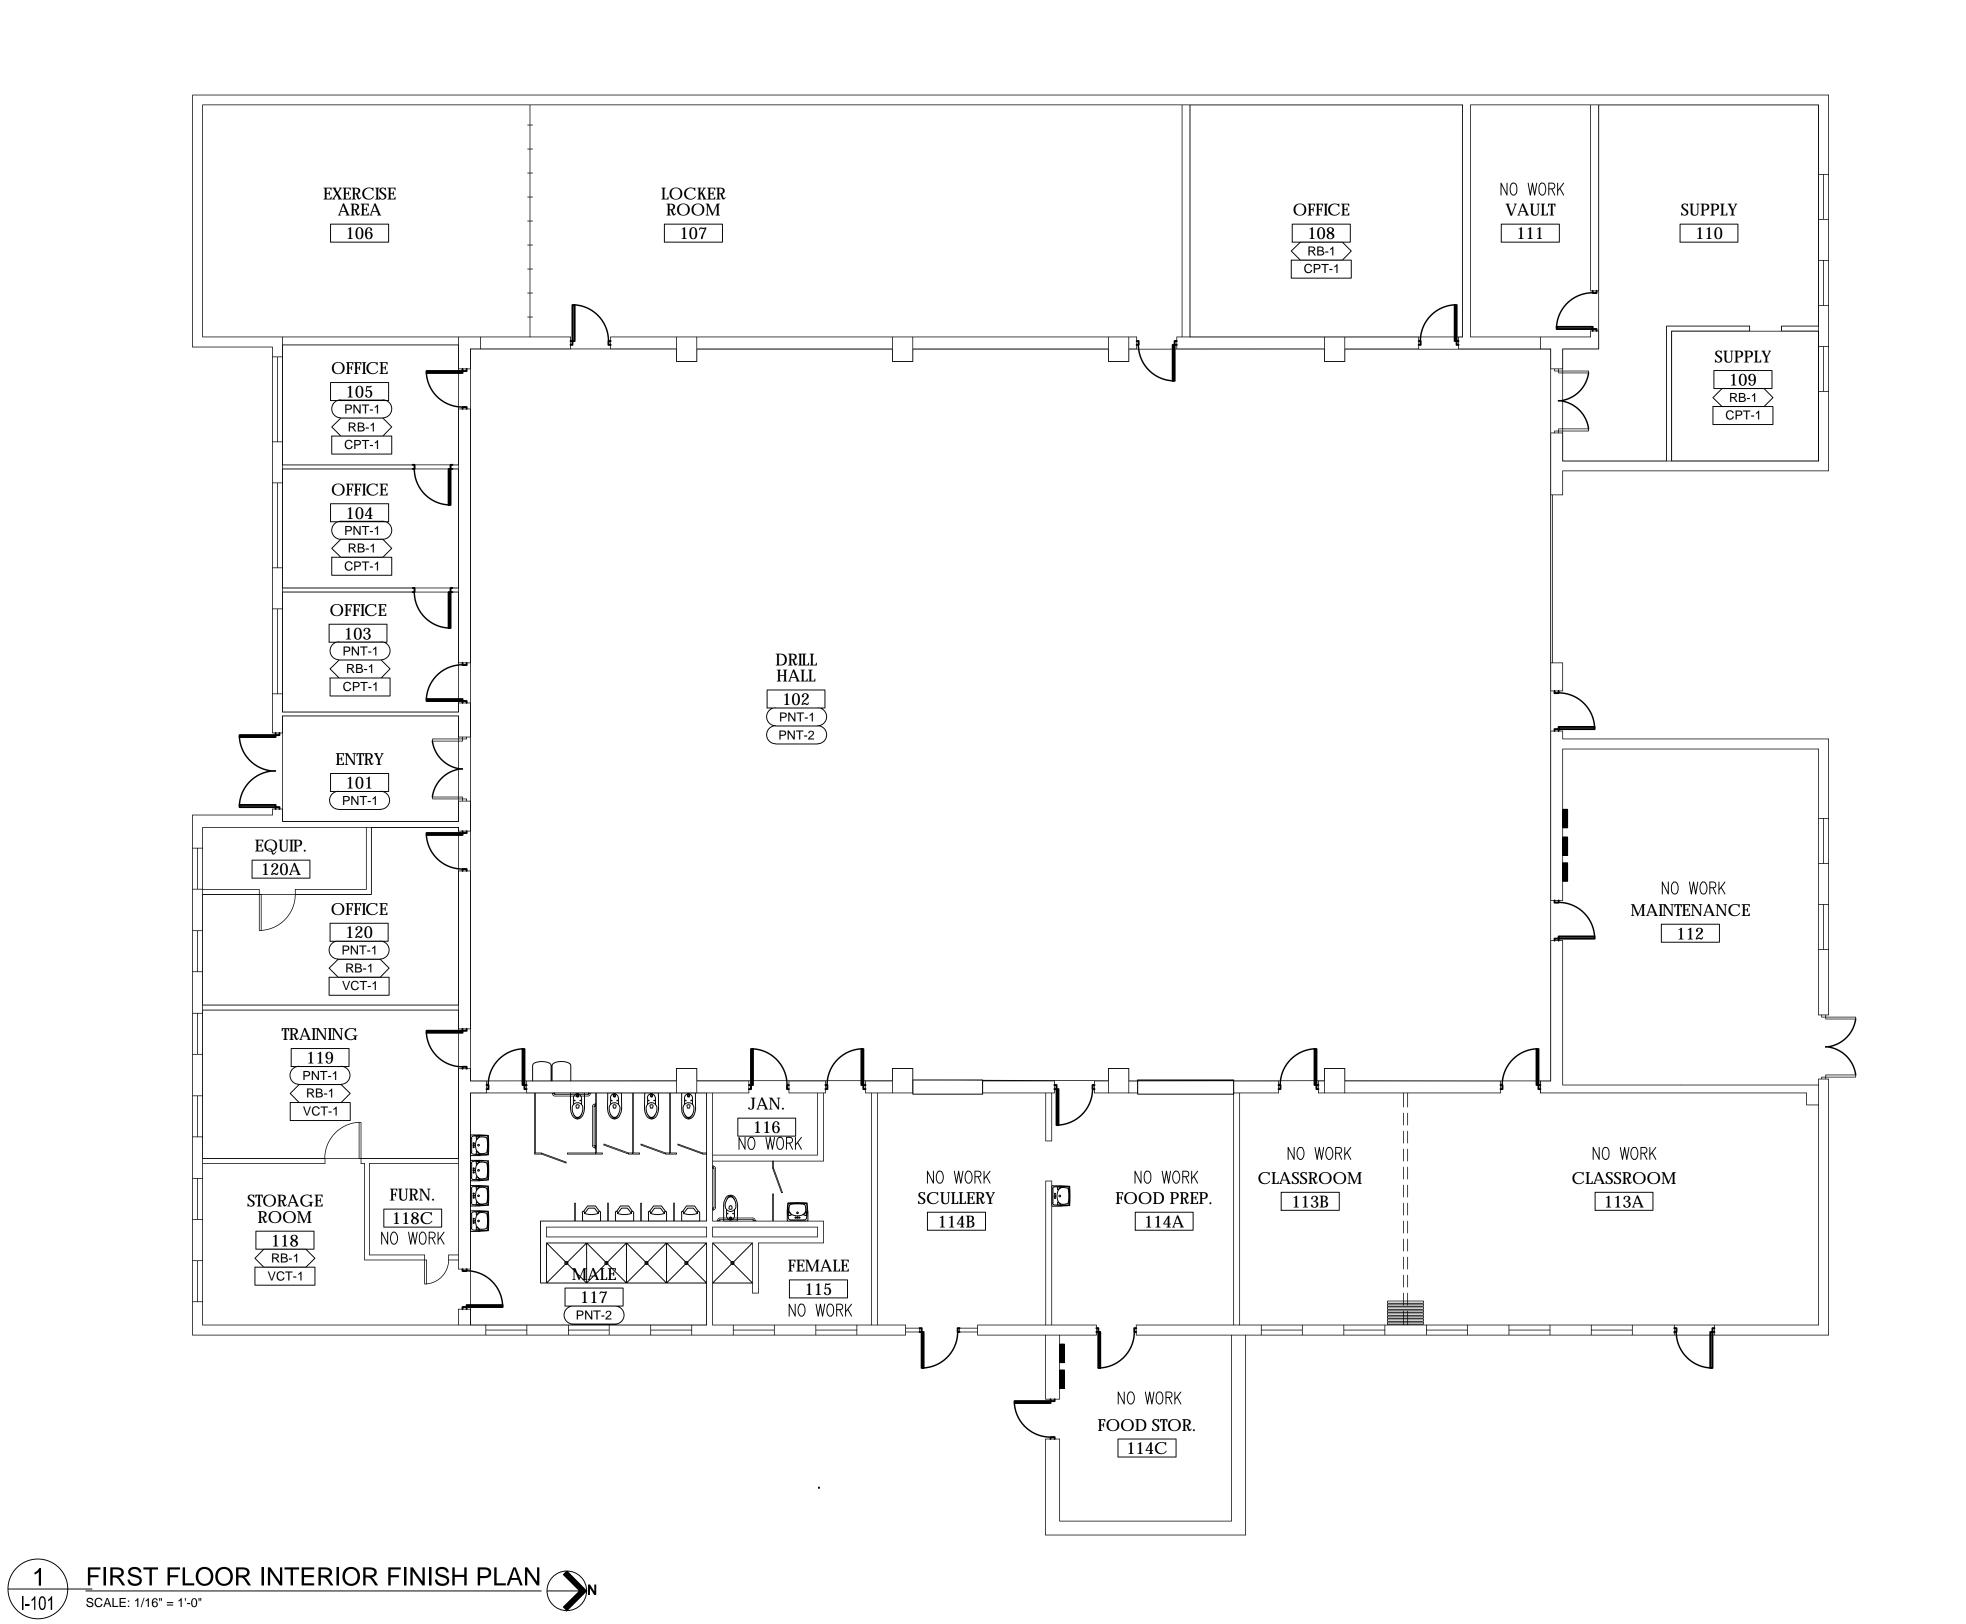
ISSUE DATE: 08/01/2019

SHEET TITLE:

REFLECTED CEILING PLAN

SHEET NUMBER:

A701



#### STATE OF MISSOURI MICHAEL L. PARSON, GOVERNOR



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PROJECT # T1931-01 SITE # 6312

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T1931-01.6312.I101

DRAWN BY: SLV

CHECKED BY: BTW

DESIGNED BY: SLV

SHEET TITLE:

INTERIOR FINISH PLAN

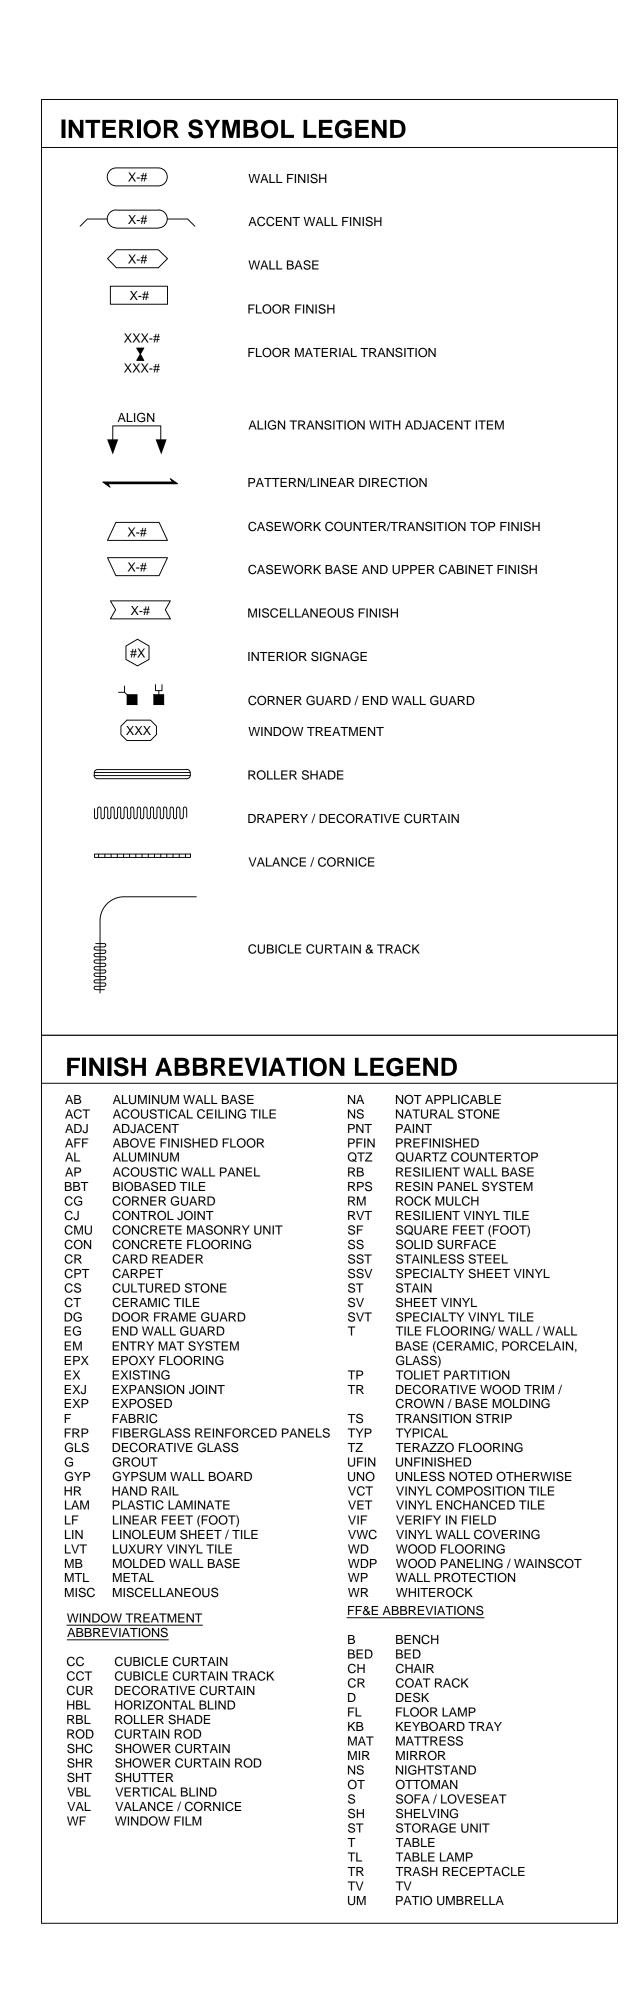
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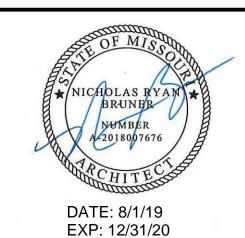
				FINIS	SH SCHEDUL	.E							
BASIS OF DESIGN WALL FINISH													
TAG	DESCRIPTION MANUFACTURER PRODUCT LINE / MODEL NUMBER SIZE COLOR FINISH TYPE COLOR LOCATION INSTALLER REMARKS /												
PNT-1	PAINT	SHERWIN WILLIAMS	-	-	TBD	TBD	-	-	-	-	-		
PNT-2	PAINT	SHERWIN WILLIAMS	-	-	TBD	TBD	-	-	-	-	-		
	BASIS OF DESIGN WALL BASE FINISH												
							GR			SUPPLIER /			
TAG	DESCRIPTION	MANUFACTURER	PRODUCT LINE / MODEL NUMBER	SIZE	COLOR	FINISH	TYPE	COLOR	LOCATION	INSTALLER	REMARKS / NOTES		
RB-1	RUBBER BASE	JOHNSONITE	4" COVE	ROLL	TBD	-	<u> -</u>	-	-	<u> -  -</u>			
				BASIS OF	DESIGN FLOORIN	G FINISH							
							GROUT SUPPLIER /						
TAG	DESCRIPTION	MANUFACTURER	PRODUCT LINE / MODEL NUMBER	SIZE	COLOR	FINISH	TYPE	COLOR	LOCATION	INSTALLER	REMARKS / NOTES		
CPT-1	CARPET TILE	MANNINGTON	SCRIPT INFINITY	24"X24"	TBD	-	-	-	-	-	-		
VCT-1	VINYL COMPOSITION TILE	ARMSTRONG WORLD INDUSTRIES	STANDARD EXCELON IMPERIAL TEXTURE	12"X12"	TBD	-	-	-	-	-	-		
BASIS OF DESIGN MISCELLANEOUS FINISH													
TAG	DESCRIPTION	MANUFACTURER	PRODUCT LINE / MODEL NUMBER	SIZE	COLOR	FINISH	GR TYPE	COLOR	LOCATION	SUPPLIER / INSTALLER	REMARKS / NOTES		
ACT-1	ACOUSTIC CEILING TILE	ARMSTRONG	ULTIMA	24" x 48"	WHITE	-	-	-	-				


NOTE: PRODUCTS SHOWN IN SCHEDULE ARE BASIS OF DESIGN UNLESS OTHERWISE NOTED. SEE SPECIFICATIONS FOR ACCEPTABLE ALTERNATE MANUFACTURERS.

ROOM FINISH SCHEDULE													
				WALLS								ILING	
				EA	ST	N	ORTH	SOUTH	W	WEST			
ROOM NO.	NAME	FLOOR	BASE	MAT'L	FIN	MAT'L	FIN	MAT'L FIN	MAT'L	FIN	FIN	HEIGHT	REMARKS
FIRST FLOOR													
101	ENTRY	-	-		PNT-1	-	PNT-1	- PNT-1	-	PNT-1	-	-	
102	DRILL HALL	-	-		PNT-1	-	PNT-1	- PNT-1	-	PNT-1	PNT-2	-	
103	OFFICE	CPT-1	RB-1		PNT-1	-	PNT-1	- PNT-1	-	PNT-1	ACT-1 -		CEILING TO BE REPLACED IN INDICATED AREAS
104	OFFICE	CPT-1	RB-1	-	PNT-1	-	PNT-1	- PNT-1	-	PNT-1	ACT-1	-	CEILING TO BE REPLACED IN INDICATED AREAS
105	OFFICE	CPT-1	RB-1	-	PNT-1	-	PNT-1	- PNT-1	-	PNT-1	ACT-1	-	CEILING TO BE REPLACED IN INDICATED AREAS
106	EXERCISE AREA	-	-	-	-	-	-		-	-	ACT-1	-	CEILING TO BE REPLACED IN INDICATED AREAS
107	LOCKER ROOM	-	-	-	-	-	-		-	-	ACT-1	-	CEILING TO BE REPLACED IN INDICATED AREAS
108	OFFICE	CPT-1	RB-1	-	-	-	-		-	-	ACT-1	-	CEILING TO BE REPLACED IN INDICATED AREAS
109	SUPPLY	CPT-1	RB-1	-	EXISTING	-	EXISTING	- EXISTING	-	EXISTING	ACT-1	-	CEILING TO BE REPLACED IN INDICATED AREAS
110	SUPPLY	-	-	-	-	-	-		-	-	-	-	
111	VAULT	-	-	-	-	-	-		-	-	-	-	
112	MAINTENANCE	-	-	-	-	-	-		-	-	-	-	
113A	CLASSROOM	-	-	-	-	-	-		-	-	-	-	
113B	CLASSROOM	-	-	-	-	-	-		-	-	-	-	
114A	FOOD PREP.	-	-	-	-	-	-		-	-	-	-	
114B	SCULLERY	-	-	-	-	-	-		-	-	-	-	
114C	FOOD STOR.	-	-	-	-	-	-		-	-	-	-	
115	FEMALE	-	-	-	-	-	-		-	-	-	-	
116	JAN.	-	-	-	-	-	-		-	-	-	-	
117	MALE	-	-	-	-		-		-	-	PNT-2	-	CEILING TO BE PATCHED IN INDICATED AREAS
118	STORAGE ROOM	VCT-1	RB-1	-	-	-	-		-	<b>I</b> -	-	<u> </u>	
118C	FURN.	<b> -</b>	-	-	-	-	-		-	-	-	-	
119	TRAINING	VCT-1	RB-1	-	PNT-1	-	PNT-1	- PNT-1	-	PNT-1	ACT-1	-	CEILING TO BE REPLACED IN INDICATED AREAS
120	OFFICE	VCT-1	RB-1	-	-	-	PNT-1		-	-	ACT-1	-	CEILING TO BE REPLACED IN INDICATED AREAS
120A	EQUIP.	-	-	-	-	-	-		-	-	-	-	


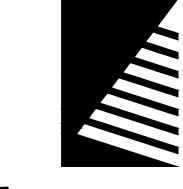
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